


	MISP AND ESMP DETAILED [	DRAWINGS
S.No.	TITLE	DRAWING NOS
1	DEBRIS DISPOSAL LOCATION LAYOUT PLAN	HP/MAN-KAL/DD-001A
2	DEBRIS DISPOSAL LOCATION LAYOUT PLAN	HP/MAN-KAL/DD-001B
3	DEBRIS DISPOSAL LOCATION LAYOUT PLAN	HP/MAN-KAL/DD-001C
4	DEBRIS DISPOSAL PLAN & SECTION	HP/MAN-KAL/DD-002
5	SEASONAL STREAMS LAYOUT PLAN	HP/MAN-KAL/SS-001
6	SUGGESTED QUARRY & BORROW AREAS LOCATION PLAN	HP/MAN-KAL/QB-001
7	TYPICAL LAYOUT OF CONSTRUCTION CAMP	HP/MAN-KAL/TCC-001
8	TYPICAL DETAIL OF SEPTIC TANK& OIL INTERCEPTOR	HP/MAN-KAL/ST-001
9	TYPICAL LAYOUT FOR CREMATORIUM @ CHN 27+650	HP/MAN-KAL/CR-001
10	RENOVATION/IMPROVEMENT OF NATURAL WATER SOURCE	HP/MAN-KAL/NWS-001
	AT KM 12+482.	TIP/IVIAIN-KAL/INVV3-001
11	RENOVATION/IMPROVEMENT OF NATURAL WATER SOURCE	HP/MAN-KAL/NWS-002
11	AT KM 18+048	HP/IVIAIN-NAL/INVV3-002
12	NOISE BARRIER AT KM 22+545 ( UNITY PUBLIC SCHOOL).	HP/MAN-KAL/NB-001
13	RESIZING OF PLATFORM AT KM22+997.	HP/MAN-KAL/RS-001
14	RELOCATION OF RELIGIOUS SHRINE AT KM 24+218.	HP/MAN-KAL/RS-002
15	RECONSTRUCTION OF PEPPAL TREE PLATFORM AT KM	HP/MAN-KAL/RS-003
	24+734.	
16	RELOCATION OF RELIGIOUS SHRINE AT KM 28+216.	HP/MAN-KAL/RS-004
17	RECONSTRUCTION OF RELIGIOUS SHRINE/PEPPAL TREE	HP/MAN-KAL/RS-005
	WITH PLATFORM AT KM 28+415.	,

CLIENT:	CONSULTANT:	PROJECT:	DESIGNED MADHU.K	TITLE: NUDEY FOR MICH & FOMD DRAWINGS
				INDEX FOR MISP & ESMP DRAWINGS
HIMACHAL PRADESH ROAD	SATRA	Himachal Pradesh State Roads Transformation Project (HPSRTP)	DRAWN DANIEL	DRAWING NO : HP/MAN-KAL/INDEX
AND OTHER INFRASTRUCTURE DEVELOPMENT	SATRA SERVICES AND SOLUTIONS PVT LTD.	* ` '	CHECKED CS/AH	
	#1-8-359 to 363, 4th Floor, Centre Point Building, SP Road, Begumpet, Secunderabad, Telangana – 500003, India.			ROAD NAME : Package-VI:
	Tel: +91 40 2784 0040, Fax: +91 40 2784 0050,	SCALE: NOT TO SCALE	APPROVED PRADEEP KAP	Upgradation of Mandi - Rewalsar - Kalkhar Road in SHEET 01 OF 01
REV DATE DESCRIPTION DESIGNED DRAWN CHECKED APPROVED	E-mail: info@satragroup.in, Web: www.satragroup.in	707 10 007.62	ATTROVED TRADEET RAI	Mandi District From Km 11+000 To Km 27+854

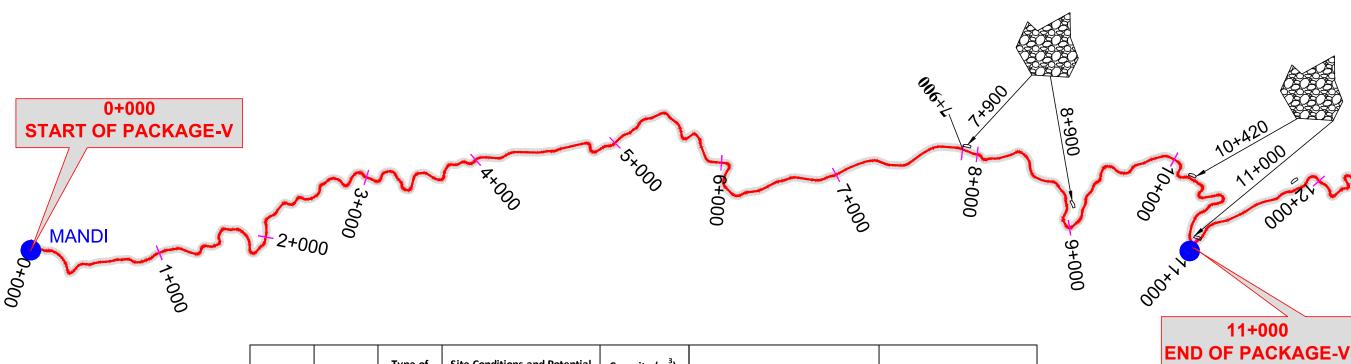


S.No.	Location	Type of Land	Site Conditions and Potential Impacts	Capacity (m³), Area (Ha)	Mitigation Measures	Remarks
1	7+900 (LHS)	Govt/PWD Land	The site is in old alignment of the road very next to the ROW, in PWD land. The site have 3 trees and they can be restored after filling.		Provision of gabion wall to avoid it getting eroded during rainy season with rainwater and to support the disposed debris. The boundary of the gabion wall needs to be follow the stream border.	widening the road and visibility to the other side vehicles since
2	8+900 (LHS)	Govt/PWD Land	The site is near to habitation. It's a barren land (valley)	3,600m <sup>3</sup> (L=80m; W=9m; H=5m)	A consultation with the local people needs to be carried prior to using the site and any operation will be done based on outcome of the consultation.	It might help to the local people to park own vehicles.
			Dust and noise pollution during disposal of material.		Trees replantation should be taken in priority stages.	
3	10+420 (LHS)	Govt/PWD Land	The site is a barren land next to the habitation and having some trees.	12,000m <sup>3</sup> (L=150mW=8m; H=10m),	Provision of gravity wall to support debris, and to avoid erosion. Provision of bioengineering measures to stabilise slope.	It help to provide parking space to the road users. And also provide access to the drinking water structure next to this location.
4	11+000 (LHS)	Govt/PWD Land	The site us barren land located next to the khud and having shrubs and trees.	20,000 m <sup>3</sup> (L=200mW=10m; H=10m),	Dump can be done in two layers with two levels, while dumping and provide gravity/gabion walls to avoid erosion to the khud.	bridge and vehicles coming

- 1. THE DEBRIS DISPOSAL LOCATIONS ARE ADJACENT TO ROAD (WITHIN 5 TO 10M AVERAGE DISTANCE) AND EASY ACCESS TO THE CONTRACTOR.
- 2. CONTRACTOR WILL ALSO APPROACH DISTRICT ADMINISTRATION FOR THE IDENTIFICATION OF SUITABLE DEBRIS DISPOSABLE SITE/LAND FOR DEBRIS, AS PER CONSTRUCTION AND DEMOLITION WASTE MANAGEMENT REULES, 2016.

# LEGEND:-




		CLIENT:	CONSULTANT:	PROJEC	T:	DESIGNED	MADHU.K	TITLE : DEBRIS DISPOSAL LOCATION PLAN
		HIMACHAL PRADESH ROAD	SATRA	Himach	nal Pradesh State Roads Transformation Project (HPSRTP)	DRAWN	DANIEL	DRAWING NO : HP/MAN-KAL/DD-001A
		AND OTHER INFRASTRUCTURE DEVELOPMENT	#1-8-359 to 363, 4th Floor, Centre Point Building, SP Road, Begumpet,		· · · · · · · · · · · · · · · · · · ·	CHECKED	CS/AH	ROAD NAME : Package-VI:
REV DATI	E DESCRIPTION DESIGNED DRAWN CHECKED APPROVED		Secunderabad, Telangana – 500003, India. Tel: +91 40 2784 0040, Fax: +91 40 2784 0050, E-mail: info@satragroup.in, Web: www.satragroup.in	SCALE:	NOT TO SCALE	APPROVED	PRADEEP KAPLA	Upgradation of Mandi - Rewalsar - Kalkhar Road in Mandi District From Km 11+000 To Km 27+854

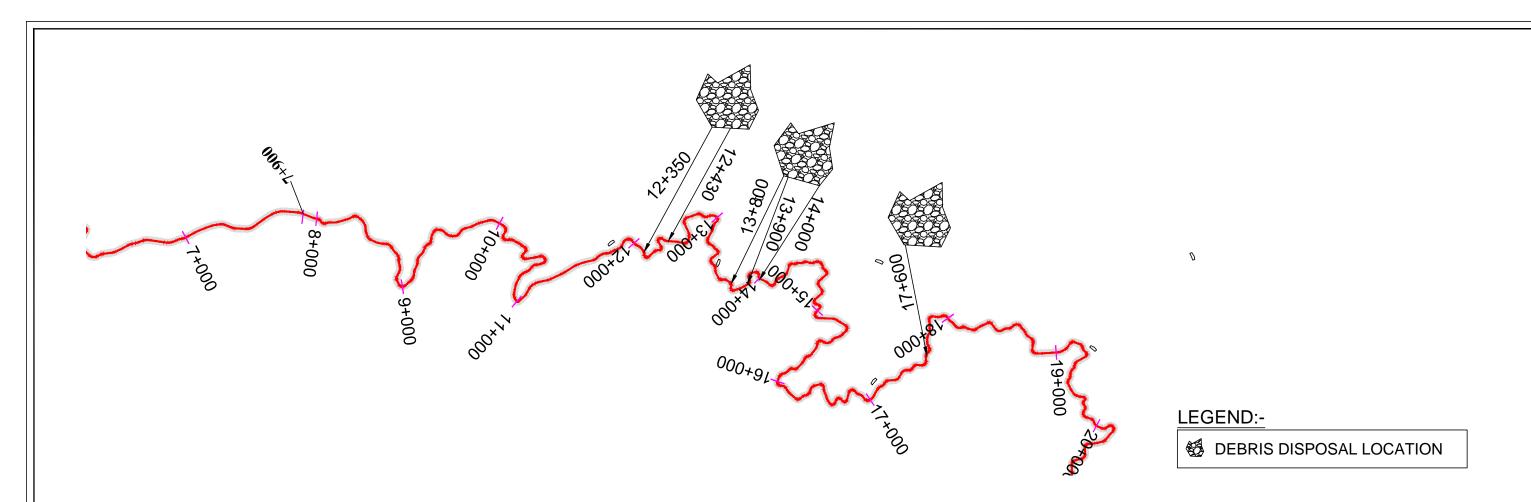

S.No.	Location	Type of Land	Site Conditions and Potential Impacts	Capacity (m³), Area (Ha)	Mitigation Measures	Remarks
5	12+350 (LHS)	Govt/PWD Land	This land is having shrubs and small trees and ifit has been filled or levelled it might be used	6,300m³ (L=70mW=15m; H=6m)	Dump can be done in two stages and entire land is in PWD ownership.  Dumping can be done with one stage of	works and maintenance. There is nala at an distance of 30 m from
	12+430 (LHS)		for social activities.	2,500 m <sup>3</sup> (L=50m; W=10m; H=5m)	Gravity wall and other layers with gabion or Gravity wall.	considering nala as boundary and without interfering with nala.
	13+800 (LHS)			2,400 m <sup>3</sup> (L=40mW=10m; H=6m)	Dump can be done in two stages and	
6	13+900 (LHS)	Govt/	This land is in barren and having 4 trees and situated in curve.	4,800m <sup>3</sup> (L=120mW=8m; H=5m)	entire land is in PWD ownership. Dumping can be done with one stage of Gravity wall and other layers with	road at curve and can gives
	14+000 (LHS)			1,600m <sup>3</sup> (L=40mW=8m; H=5m),	gabion or Gravity wall.	solutions.
7	17+600 (LHS)	Govt/PWD Land	The land identified for debris disposal is a barren. Have 5 tree on the boundary of the area.  There is a nala coming from natural drinking water source.	50,000m <sup>3</sup> (L=250m; W=20m; H=10m),	Provision of gabion/gravity wall to support the debris, Provision of bioengineering measures to stabilise slope and aesthetics. Tree will not be impacted because these are in the periphery of the area.	future years and easy to expand. The dump should made by considering the nala as border and

- 1. THE DEBRIS DISPOSAL LOCATIONS ARE ADJACENT TO ROAD (WITHIN 5 TO 10M AVERAGE DISTANCE) AND EASY ACCESS TO THE CONTRACTOR.
- 2. CONTRACTOR WILL ALSO APPROACH DISTRICT ADMINISTRATION FOR THE IDENTIFICATION OF SUITABLE DEBRIS DISPOSABLE SITE/LAND FOR DEBRIS, AS PER CONSTRUCTION AND DEMOLITION WASTE MANAGEMENT REULES,2016.

	CLIENT:	CONSULTANT:	PROJECT	Т:	DESIGNED	MADHU.K	TITLE : DEBRIS DISPOSAL LOCATION PLAN
			Himach.	al Pradesh State Roads Transformation	224444	DANIE!	
	HIMACHAL PRADESH ROAD	SAT?A	Immacin	Project (HPSRTP)	DRAWN	DANIEL	DRAWING NO : HP/MAN-KAL/DD-001B
	AND OTHER INFRASTRUCTURE DEVELOPMENT	SATRA SERVICES AND SOLUTIONS PVT LTD.		, , ,	CHECKED	CS/AH	
	CORPORATION LIMITED.	#1-8-359 to 363, 4th Floor, Centre Point Building, SP Road, Begumpet, Secunderabad, Telangana – 500003, India.					ROAD NAME : Package-VI:
		Tel: +91 40 2784 0040, Fax: +91 40 2784 0050,	SCALE:	NOT TO SCALE	APPROVED	PRADEEP KAPLA	Upgradation of Mandi - Rewalsar - Kalkhar Road in SHEET 02 OF 03
REV DATE DESCRIPTION DESIGNED DRAWN CHECKED APPROVED	2021\12.06.2021.PKG-6\04.MISP. FSMPMDR 26. DD 01.dwa	E-mail: info@satragroup.in, Web: www.satragroup.in	00/122		ATTROVED	THADELT KALDA	Mandi District From Km 11+000 To Km 27+854

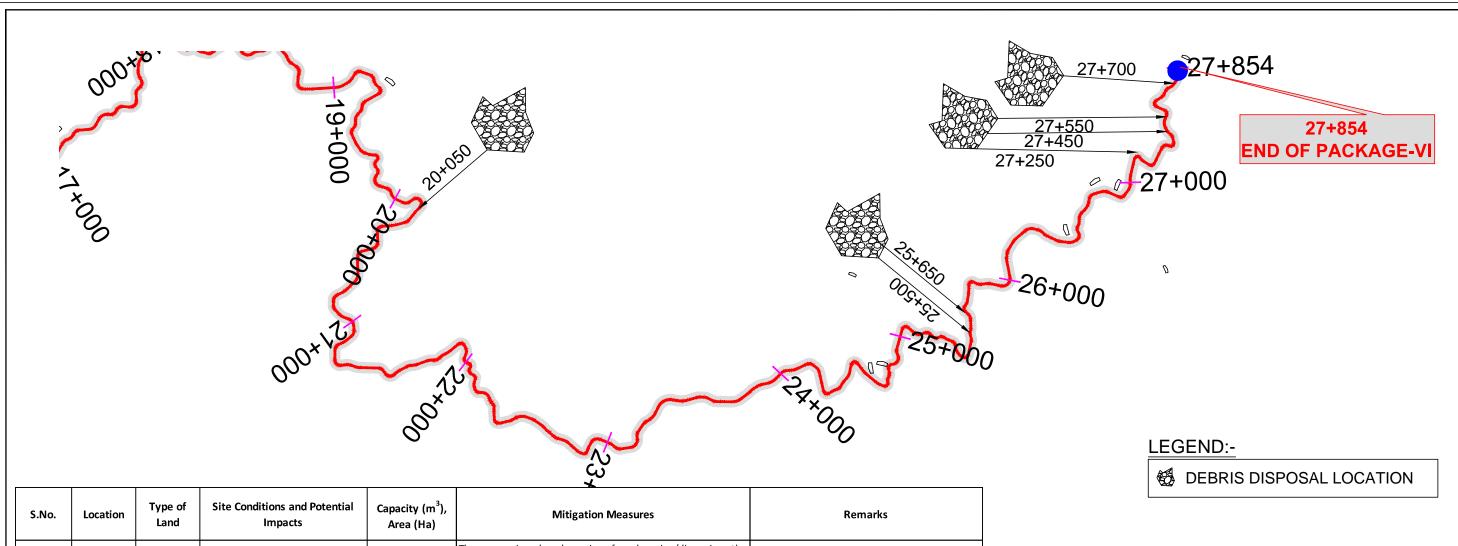


s.	.No.	Location	Type of Land	Site Conditions and Potential Impacts	Capacity (m³), Area (Ha)	Mitigation Measures	Remarks
	8	20+050 (LHS)	Govt/PWD Land	It's a open land and having steep slope and tees.	50,000m <sup>3</sup> (L=200mW=25m; H=10m),	The area is already using for dumping/disposing the landslides waste and the remaining area can be used for new site to dispose. The Bio- engineering solutions can help to improve the slope stability and aesthetics.	It may increase the safety of the road and the
	9	25+500 (LHS)	Govt/PWD Land	The land is in ownership of PWD and having 7 tall trees, there is link road at downside at a	2,000 m <sup>3</sup> (L=40m; W=10m; H=5m)	Provision of gabion wall to support debris, Provision of bioengineering measures to stabilise slope.  And also it helps to develop more green space.	Prior consultation is must to avoid public resistance from the users of downside road.
	10	25+650 (LHS)	Govt/PWD Land	Open land valley side having a seasonal stream at bottom, 7 number of trees were situated which were more than 30 m tall.	2,000 m <sup>3</sup> (L=50m; W=10m; H=4m),	Provision of gabion/gravity wall to support debris, and escapes the movement of earthen material form muck, bio-engineering provisions can help to improve the vegetation.	It may increase the safety of the road and the wall should be closed at down form end of nala.
	11	27+250 (LHS)	Govt/PWD Land	Its under ownership of PWD and there were 2 no of trees.	4,000 m <sup>3</sup> (L=100m; W=10m; H=4m),	Provision of gabion/gravity wall to support debris, and escapes the movement of earthen material form muck, bio-engineering provisions can help to improve the vegetation.	
	12	27+450 (LHS) 27+550 (LHS)	Govt/PWD Land	Its under ownership of PWD and there were 5 no of trees.	2,560m <sup>3</sup> (L=80m; W=8m; H=4m) 2,800m <sup>3</sup> (L=100m; W=7m; H=4m)	Provision of gabion/gravity wall to support debris, and escapes the movement of earthen material form muck, bioengineering provisions can help to improve the vegetation.	
	13	27+700 (LHS)	Govt/PWD Land	Its under ownership of PWD and there is a nala at curve and a Samshanghat at downside	2,100m³ (L=70mW=5m; H=6m)	The dump should terminate next to the Samshanghat and the nala need to extend till the wall to avoid over weight on wall in monsoon.	Help to improve the safety in future years and easy to expand. The dump should made by considering the nala as border and if necessary, extend the outlet to the end of dump boundary.  The villagers need a proper access to the shamsahngaht.
	'	Total			1,72,600 m <sup>3</sup>		
				CLIENT		CONSULTANT:	DPO IECT:

- 1. THE DEBRIS DISPOSAL LOCATIONS ARE ADJACENT TO ROAD (WITHIN 5 TO 10M AVERAGE DISTANCE) AND EASY ACCESS TO THE CONTRACTOR.
- 2. CONTRACTOR WILL ALSO APPROACH DISTRICT ADMINISTRATION FOR THE IDENTIFICATION OF SUITABLE DEBRIS DISPOSABLE SITE/LAND FOR DEBRIS, AS PER CONSTRUCTION AND DEMOLITION WASTE MANAGEMENT REULES, 2016.


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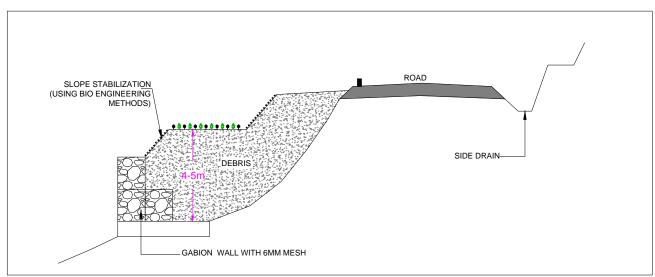
SHEET 03 OF 03


		CLIENT:	CONSULTANT:	PROJE	CT:	DESIGNED	MADHILK	TITLE:
$\ \cdot\ $				□ima	chal Pradesh State Roads Transformation			DEBRIS DISPOSAL LOCATION PLAN
		HIMACHAL PRADESH ROAD	SATRA	Hilliac	Project (HPSRTP)	DRAWN	DANIEL	DRAWING NO : HP/MAN-KAL/DD-001C
╁		AND OTHER INFRASTRUCTURE DEVELOPMEN CORPORATION LIMITED.	#1-8-359 to 363, 4th Floor, Centre Point Building, SP Road, Begumpet,		, , ,	CHECKED	CS/AH	ROAD NAME : Package-VI:
	REV DATE DESCRIPTION DESIGNED DRAWN CHECKED APPROV		Secunderabad,Telangana – 500003, India. Tel: +91 40 2784 0040, Fax: +91 40 2784 0050, E-mail: info@satragroup.in, Web: www.satragroup.in	SCALE:	NOT TO SCALE	APPROVED	PRADEEP KAPLA	Upgradation of Mandi - Rewalsar - Kalkhar Road in Mandi District From Km 11+000 To Km 27+854
\\192	92.168.1.240\projects\$\0.1041055-HPSRTP\0.4 Designs\0.1 Highways\0.2 Drawings\Working\0.5 DPR 2019 12 27\PKG-5 MDR-2	22.06.2021\12.06.2021 PKG-6\04. MISP_ESMP\MDR 26 DD 01.dwa		l .		1	1	



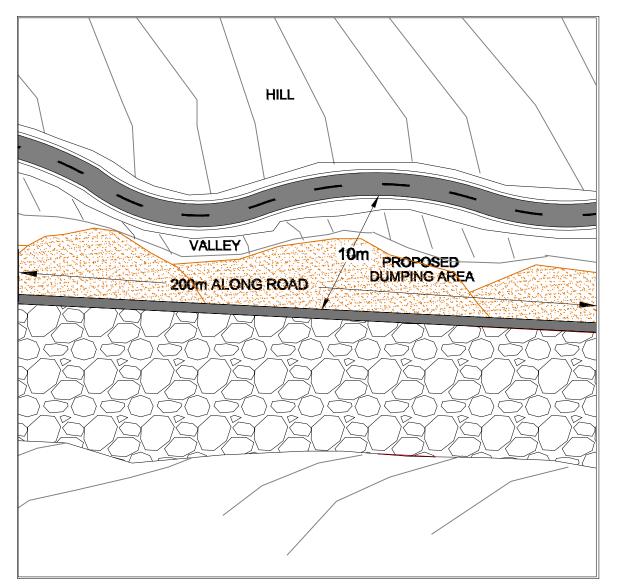





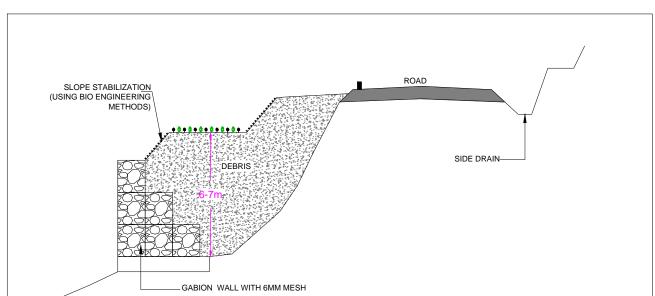

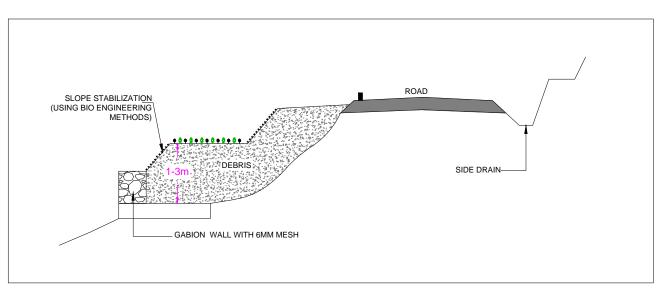

## TYPICAL CROSS SECTIONS

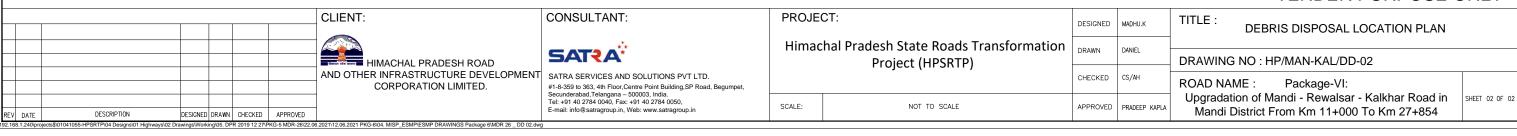

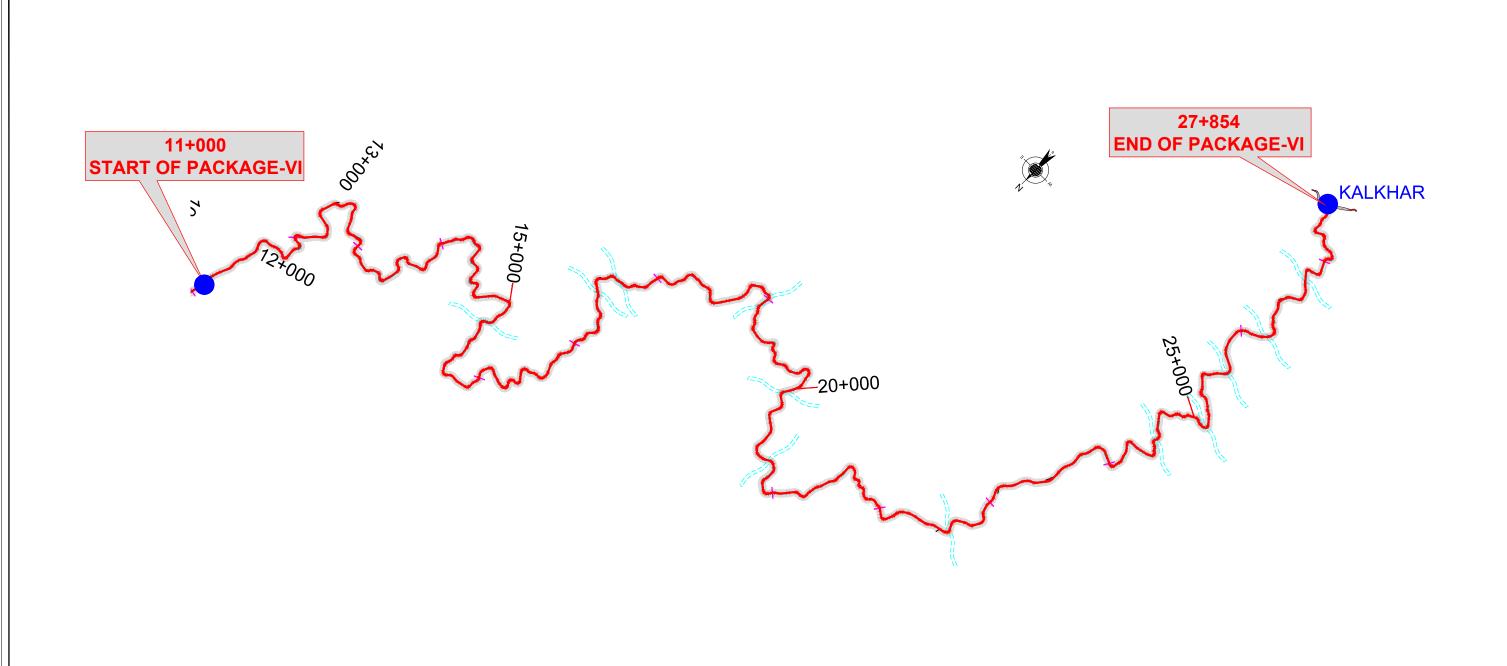

# LEGEND:-



## SEASONAL STREAMS

DESIGNED MADHU.K

# TENDER PURPOSE ONLY

							CLIENT:
H							AND OTHER
F							
RE	V DATE	DESCRIPTION	DESIGNED	DRAWN	CHECKED	APPROVED	

CONSULTANT:

HIMACHAL PRADESH ROAD
AND OTHER INFRASTRUCTURE DEVELOPMENT
CORPORATION LIMITED.

SATRA SERVICES AND SOLUTIONS PVT LTD.
#1-8-359 to 363, 4th Floor, Centre Point Building, SP Road, Begumpet, Secunderabad, Telangana – 500003, India.
Tel: +91 40 2784 0040, Fax: +91 40 2784 0050, E-mail: info@satragroup.in, Web: www.satragroup.in

Himachal Pradesh State Roads Transformation
Project (HPSRTP)

NOT TO SCALE


PROJECT:

n	DRAWN	DANIEL	
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			Up
	APPROVED	PRADEEP KAPLA	İ

TITLE :
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DRAWING NO : HP/MAN-KAL/SS-001
DOAD MAME Dealer was MI

	NO/ID IN/IIIL : I deltage VI.			
Ī	Upgradation of Mandi - Rewalsar - Kalkhar Road in	SHEET 01 OF	01	
	Mandi District From Km 11+000 To Km 27+854			

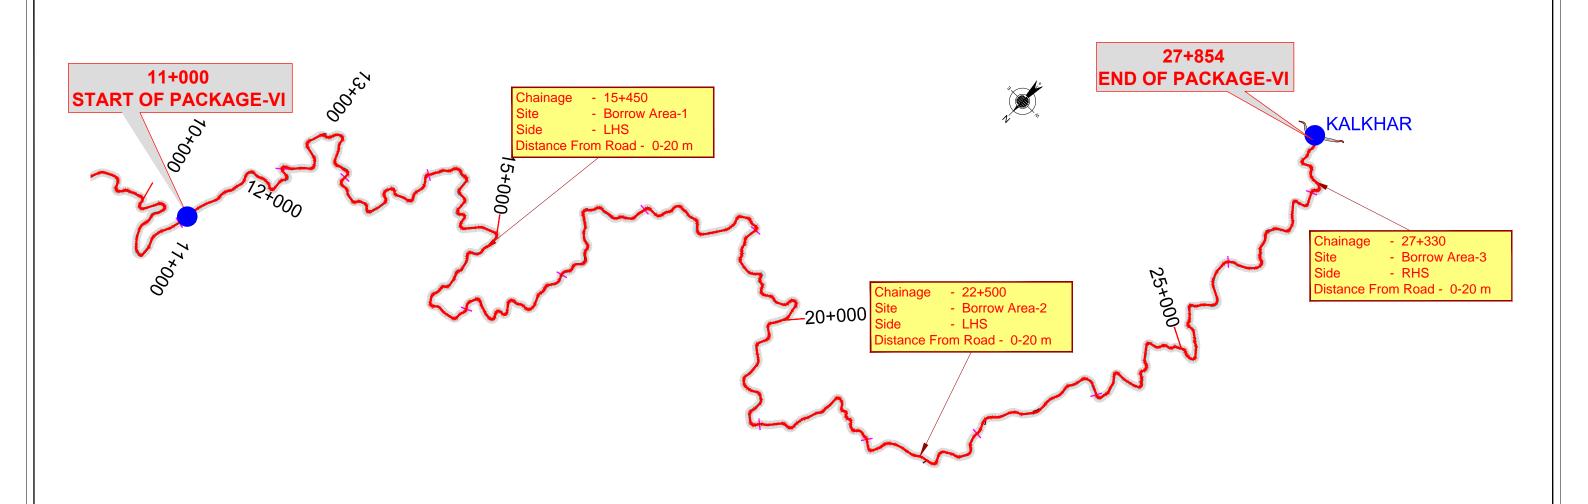


1. THE ABOVE LOCATIONS ARE INDICATIVE ONLY, THE CONTRACTOR HAS TO IDENTIFY QUARRY AND BARROW AREA LOCATIONS ON HIS OWN AS PER RELEVANT SPECIFICATIONS AND STANDARDS AND IN CONSULTATION WITH PROJECT MANAGER.

# TENDER PURPOSE ONLY


**BORROW AREA** 

AGGREGATE QUARRY

C						CLIENT:	CONSULTANT:	PROJEC	CT:	DESIGNED	MADHU.K	TITLE: SUGGESTED QUARRY &
╟								Himac	hal Pradesh State Roads Transformation	DDAWN	DANIEL	BORROW AREAS LOCATION PLAN
						Market vite week III IVIACHAL PRADESH ROAD	SAIZA	Project (HPSRTP)	DRAWN	DANIEL	DRAWING NO : HP/MAN-KAL/QB-001	
╟						AND OTHER INFRASTRUCTURE DEVELOPMENT CORPORATION LIMITED.	#1-8-359 to 363, 4th Floor, Centre Point Building, SP Road, Begumpet,			CHECKED	CS/AH	ROAD NAME : Package-VI:
	PEV DATE	DESCRIPTION	DESIGNED DRAWN	CHECKED	APPROVED		Secunderabad,Telangana – 500003, India. Tel: +91 40 2784 0040, Fax: +91 40 2784 0050, E-mail: info@satragroup.in, Web: www.satragroup.in	SCALE:	NOT TO SCALE	APPROVED	PRADEEP KAPLA	Upgradation of Mandi - Rewalsar - Kalkhar Road in Mandi District From Km 11+000 To Km 27+854

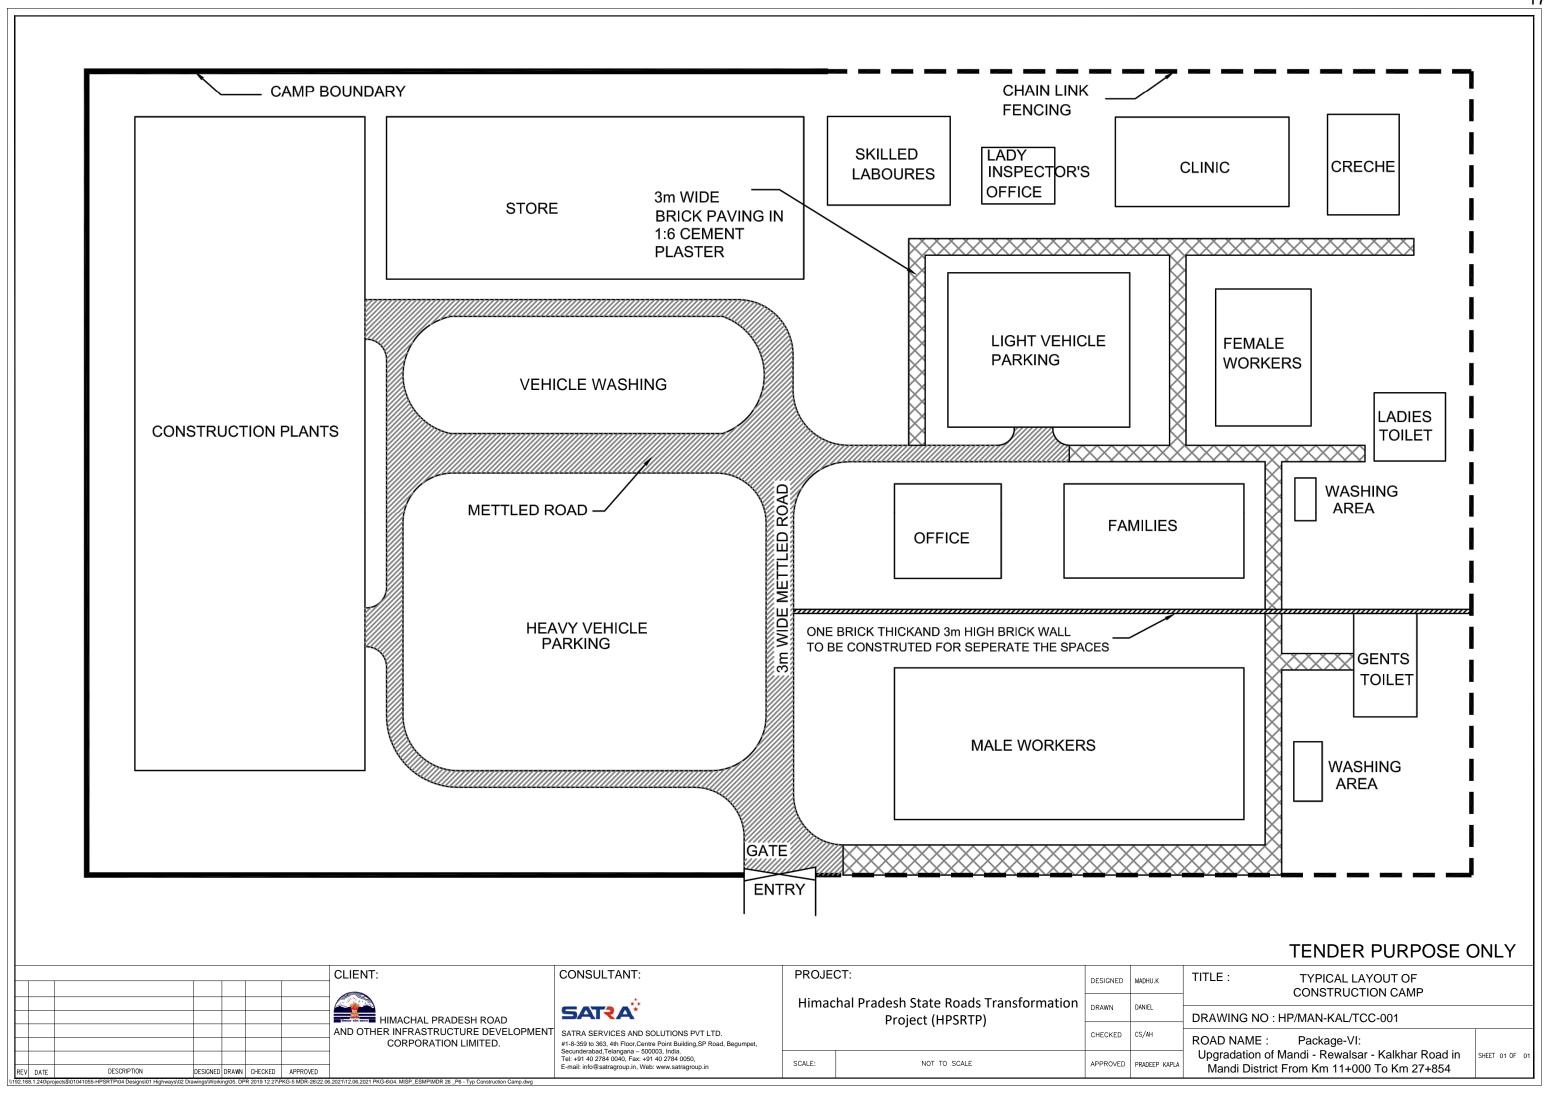

#### SEPTIC TANK AND OIL INTERCEPTOR

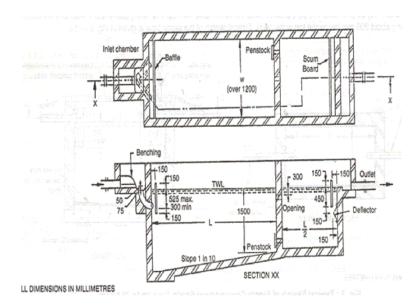

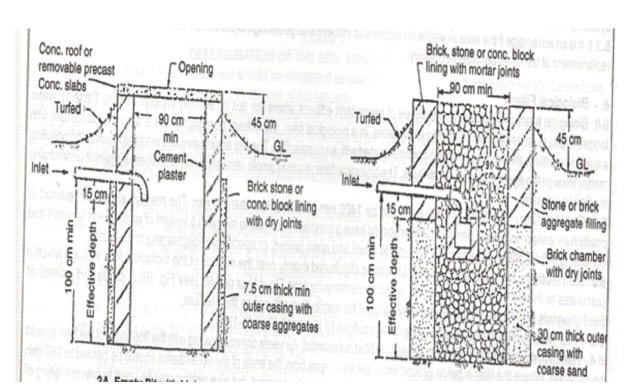
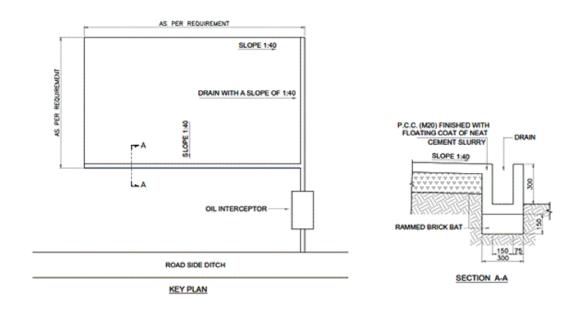
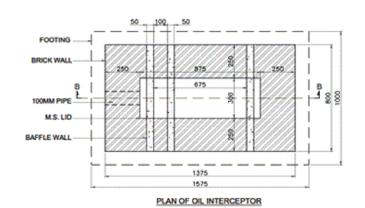


FIGURE. SEPTIC TANK SPECIFICATIONS







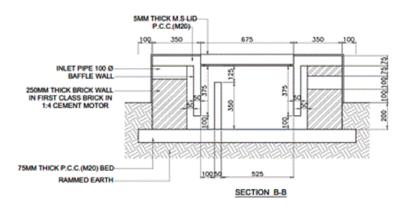


FIGURE. OIL INTERCEPTOR

		CLIENT:	CONSULTANT:	PROJECT:	DESIGNED	MADHU.K	TITLE : TYPICAL DETAILS OF SEPTIC TANK & OIL INTERCEPTOR					
		HIMACHAL PRADESH ROAD	#1-8-359 to 363, 4th Floor, Centre Point Building, SP Road, Begumpet,	Himachal Pradesh State Roads Transformation Project (HPSRTP)	DRAWN	DANIEL	DRAWING NO : HP/MAN-KAL/ST-001					
		AND OTHER INFRASTRUCTURE DEVELOPMENT CORPORATION LIMITED.			CHECKED CS/AH		ROAD NAME : Package-VI:					
REV DATE	DESCRIPTION DESIGNED DRAWN CHECKED APPROVED		Secunderabad, Telangana – 500003, India. Tel: +91 40 2784 0040, Fax: +91 40 2784 0050, E-mail: info@satragroup.in, Web: www.satragroup.in	SCALE: NOT TO SCALE	APPROVED	PRADEEP KAPLA	Upgradation of Mandi - Rewalsar - Kalkhar Road in Mandi District From Km 11+000 To Km 27+854					
\\192.168.1.240\pr	2.168.1.240projects\$01041055-HPSRTP04 Designs\011 Highways\02 Drawings\Working\05. DPR 2019 12 27/PKG-5 MDR-26\022.06.2021\12.06.2021 PKG-6\010.4 MISP_ESMPMDR 26_P6 - Septic tank-Oil interceptor.dwg											

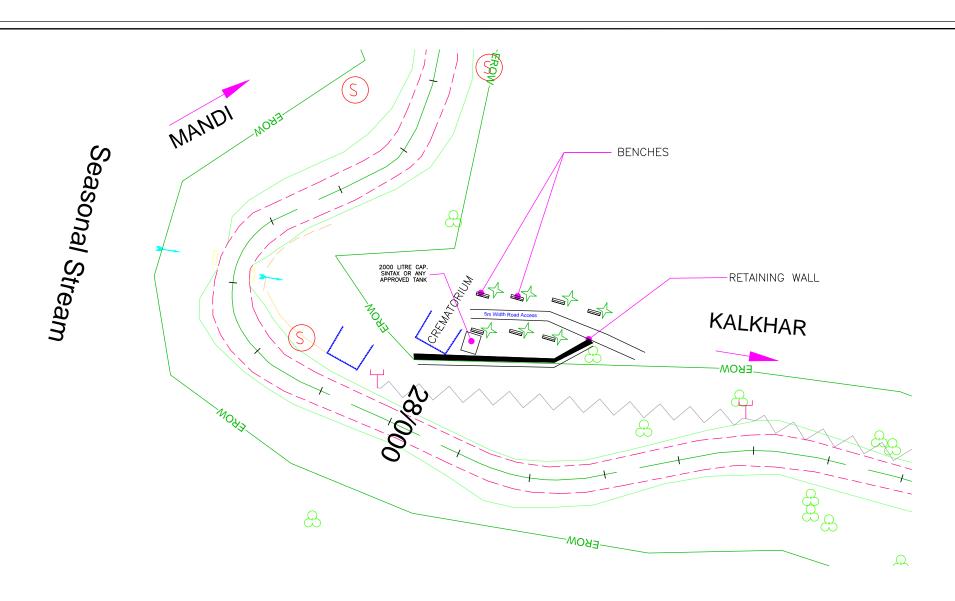

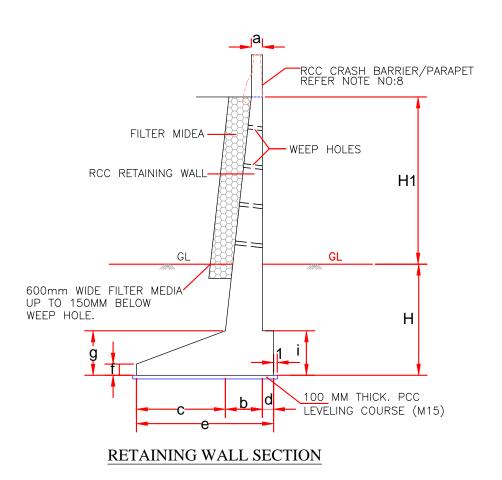


### SCHEDULE OF REINFORCEMENT

			I			I	I	
Height (H1)	Shape	1000	2000	3000	4000	5000	6000	7000
Bar Mark	of bars	Bar Dia & Spacing						
1		10 Ф 150 С/С	12 Φ 120 C/C	16 Ф 200 С/С	16 Ф 120 С/С	20 Ф 130 С/С	20Ф100 С/С	20 Ф 100 С/С
2		10 Ф 200 С/С	10 ₹ 200 С/С	10 Φ 110 C/C	12 ₹ 100 C/C	12 ₹ 100 C/C	12 ♥ 100 C/C	16 Φ 100 C/C
3		12 ₹ 150 C/C	16 Φ 150 C/C	20 ₹ 100 C/C	25 ₹ 120 C/C	25 ₹ 100 C/C	25 Φ 110 C/C	32 ₹ 120 C/C
4	J	12 ₹ 200 C/C	12 ₹ 200 C/C	12 ₹ 200 C/C	12 ₹ 180 C/C	12 ₹ 180 C/C	12 ₹ 200 C/C	12 ₹ 200 C/C
5		_	12 ₹ 200 C/C	12 ₹ 200 C/C	12 Φ 180 C/C	12 ₹ 180 C/C	16 Φ 200 C/C	20 Φ 200 C/C
6	_	10 Ф 200 С/С	10 Ф 200 С/С	10 Ф 200 С/С	10 Φ 150 C/C	10 0 50 C/C	12 Φ 150 C/C	12 ₹ 150 C/C
7		10 ₹ 200 C/C	10 Φ 250 C/C	10 ₹ 200 C/C	10 Φ 150 C/C	10 Φ 150 C/C	10 Φ 150 C/C	12 ₹ 150 C/C
m		-	1400	1800	1800	2000	2700	4200

## NOTES:

1. ALL DIMENSIONS ARE IN METRES UNLESS OTHERWISE SPECIFIED.

		CLIENT:	CONSULTANT:	PROJE		DESIGNED		TITLE: TYPICAL LAYOUT FOR CREMATORIUM @ CHN 27+650
		HIMACHAL PRADESH ROAD	SATRA	Himad	hal Pradesh State Roads Transformation Project (HPSRTP)	DRAWN	DANIEL	DRAWING NO : HP/MAN-KAL/CR-001
		AND OTHER INFRASTRUCTURE DEVELOPMENT CORPORATION LIMITED.	SATRA SERVICES AND SOLUTIONS PVT LTD. #1-8-359 to 363, 4th Floor,Centre Point Building,SP Road, Begumpet,		rroject (Hr3K1F)		CS/AH	ROAD NAME : Package-VI:
REV DATE	DESCRIPTION DESIGNED DRAWN CHECKED APPROVED		Secunderabad, Telangana – 500003, India. Tel: +91 40 2784 0040, Fax: +91 40 2784 0050, E-mail: info@satragroup.in, Web: www.satragroup.in	SCALE:	NOT TO SCALE	APPROVED	PRADEEP KAPLA	Upgradation of Mandi - Rewalsar - Kalkhar Road in  Mandi District From Km 11+000 To Km 27+854

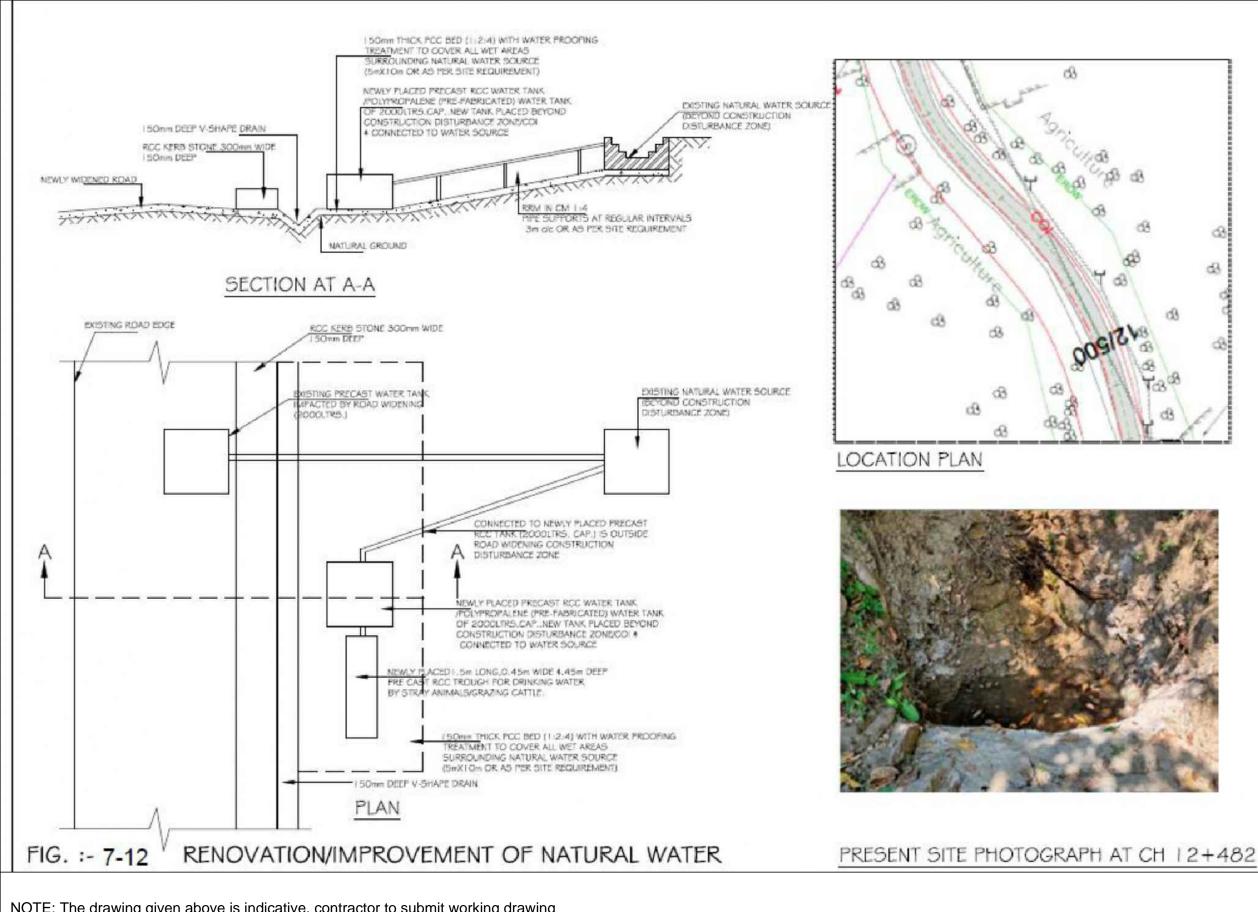

Source at Ch 12+482

1. Carryout minor repairs to exterior


Items for Renovation of Natural Water

- Carryout minor repairs to exterior surfaces of natural water source structure, without disturbing source point
- Install a new pre-cast RCC tank of 2000 litres capacity or rectangular shaped poly-propalene (pre-fabricated) tank in a suitable location in close proximity to natural water source, on a firm and 100 mm thick level bed of PCC.
- Place a pre-cast concrete trough 1.5 m long, 0.45 m wide and 0.45 m deep to facilitate drinking of water by stary animals and grazing cattle and connect it to pre-cast water storage tank as shown in drawing /as per site requirements
- 4. Level the area and provide 150 mm thick PCC in and around the natural water source, storage tank and trough, and PCC finished with sloping outwards to drain the water and no water stagnate as required /per site condition
- Providing two coats of exterior paint/white washing to the entire water body structure as per site conditions/site requirements
- Removal and/or clearing of unwanted debris/wate material surrounding the water source and disposal of the same at an approved location
- "3M" make high intensity retro reflective conspicuity tape (2" wide X 1mtr length) shall be pasted along edge of road near structure

Note: All renovation /conservation work at the natural water source shall be carried out in close consultation with local community leaders/regular users of water source. All suggestions shall be duly considered with prior approval of Engineer-in-Charge.

NOTE: The drawing given above is indicative, contractor to submit working drawing in consultation with local authorities, CSC, HPRIDC, for taking up the work.

		CLIENT:	CONSULTANT:	PROJEC	eT:	DESIGNED	MADHU.K	TITLE : RENOVATION/IMPROVEMENT OF NATURAL WATER SOURCE AT KM12+482.	
		HIMACHAL PRADESH ROAD  SATÇA		Himachal Pradesh State Roads Transformation Project (HPSRTP)		DRAWN	DANIEL	DRAWING NO : HP/MAN-KAL/NWS-001	
		AND OTHER INFRASTRUCTURE DEVELOPMENT CORPORATION LIMITED.	#1-8-359 to 363, 4th Floor, Centre Point Building, SP Road, Begumpet,			CHECKED CS/AH		ROAD NAME : Package-VI:	
REV DATE	: DESCRIPTION DESIGNED DRAWN CHECKED APPROVED	Secunderabad, Telangana – 500003, India.  Tel: +91 40 2784 0040, Fax: +91 40 2784 0050,  E-mail: info@satragroup.in, Web: www.satragroup.in		SCALE:	NOT TO SCALE	APPROVED	PRADEEP KAPLA	Upgradation of Mandi - Rewalsar - Kalkhar Road in Mandi District From Km 11+000 To Km 27+854	

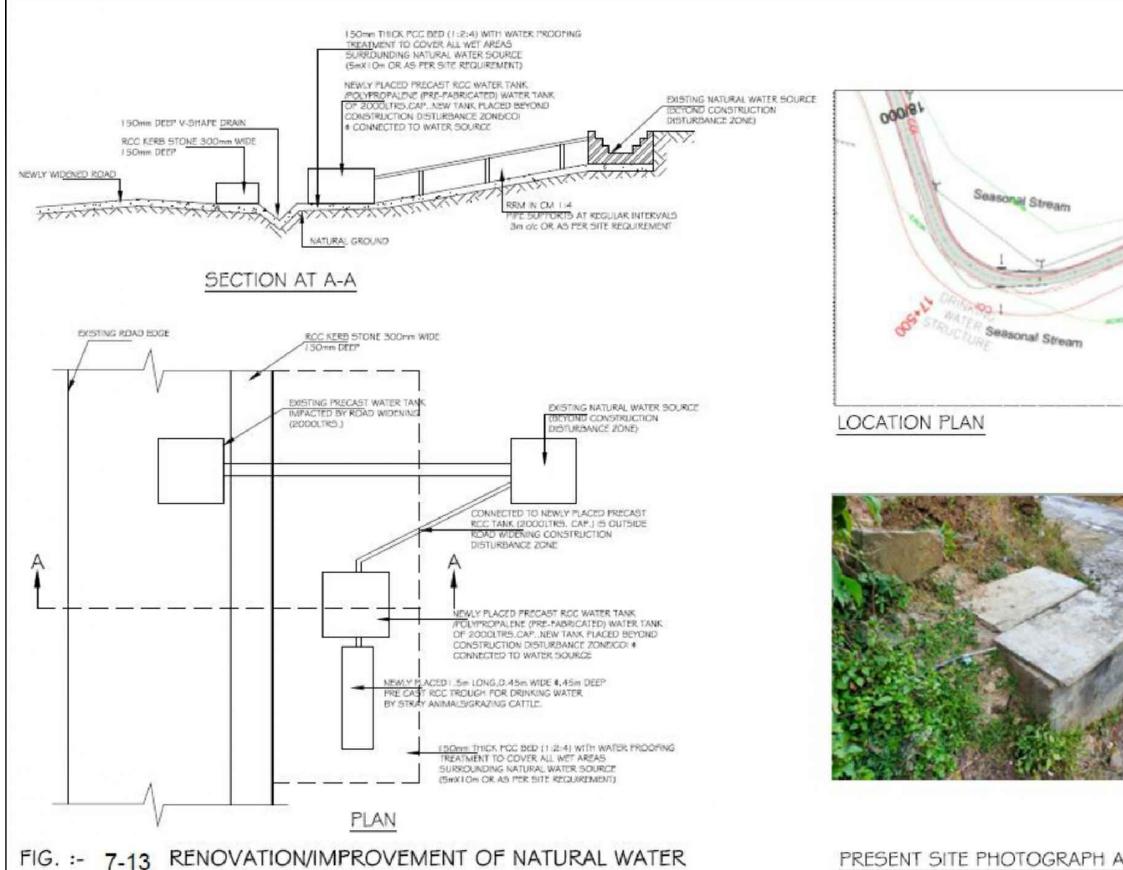

PRESENT SITE PHOTOGRAPH AT CH 18+048

#### Items for Renovation of Natural Water Source at Ch 18+048


- 1. Carryout minor repairs to exterior surfaces of natural water source structure, without disturbing source
- 2. Install a new pre-cast RCC tank of 2000 litres capacity or rectangular poly-propalene (pre-fabricated) tank in a suitable location in close proximity to natural water source, on a firm and 100 mm thick level bed of PCC.
- 3. Dismantle the existing pre-cast tank and establish connection with newly placed tank with required pipe connections and plumbing fixtures
- 4. Place a pre-cast concrete trough 1.5 m long, 0.45 m wide and 0.45 m deep to facilitate drinking of water by stary animals and grazing cattle and connect it to pre-cast water storage tank as shown in drawing /as per site requirements
- 5. Level the area and provide 150 mm thick PCC in and around the natural water source, storage tank and trough, and PCC finished with sloping outwards to drain the water and no water stagnate as required /per site condition
- 6. Providing two coats of exterior paint/white washing to the entire water body structure as per site conditions/site requirements
- 7. Removal and/or clearing of unwanted debris/wate material surrounding the water source and disposal of the same at an approved
- 7. "3M" make high intensity retro reflective conspicuity tape (2" wide X 1mtr length) shall be pasted along edge of road near structure

Note: All renovation /conservation work at the natural water source shall be carried out in close consultation with local community leaders/regular users of water source. All suggestions shall be duly considered with prior approval of Engineer-in-Charge.

NOTE: The drawing given above is indicative, contractor to submit working drawing in consultation with local authorities, CSC, HPRIDC, for taking up the work.

SOURCE AT CH 18+048.

	CLIENT: CONSULTANT: F		PROJE	CT:	DESIGNED	MADHU.K	TITLE: RENOVATION/IMPROVEMENT OF NATURAL WATER SOURCE AT KM18+048.								
						HIMACHAL PRADESH ROAD	SATRA	SATRA		hal Pradesh State Roads Transformation Project (HPSRTP)	DRAWN DANIEL		DRAWING NO : HP/MAN-KAL/NWS-002		
						AND OTHER INFRASTRUCTURE DEVELOPMENT CORPORATION LIMITED.	#1-8-359 to 363, 4th Floor, Centre Point Building, SP Road, Begumpet,	TD.		CHECKED	CS/AH	ROAD NAME : Package-VI:			
REV [	DATE	DESCRIPTION	DESIGNED DRAWN	CHECKED	APPROVED		Secunderabad, Telangana – 500003, India. Tel: +91 40 2784 0040, Fax: +91 40 2784 0050, E-mail: info@satragroup.in, Web: www.satragroup.in	SCALE:	NOT TO SCALE	APPROVED	PRADEEP KAPLA	Upgradation of Mandi - Rewalsar - Kalkhar Road in Mandi District From Km 11+000 To Km 27+854	02 <b>0F</b> 02		

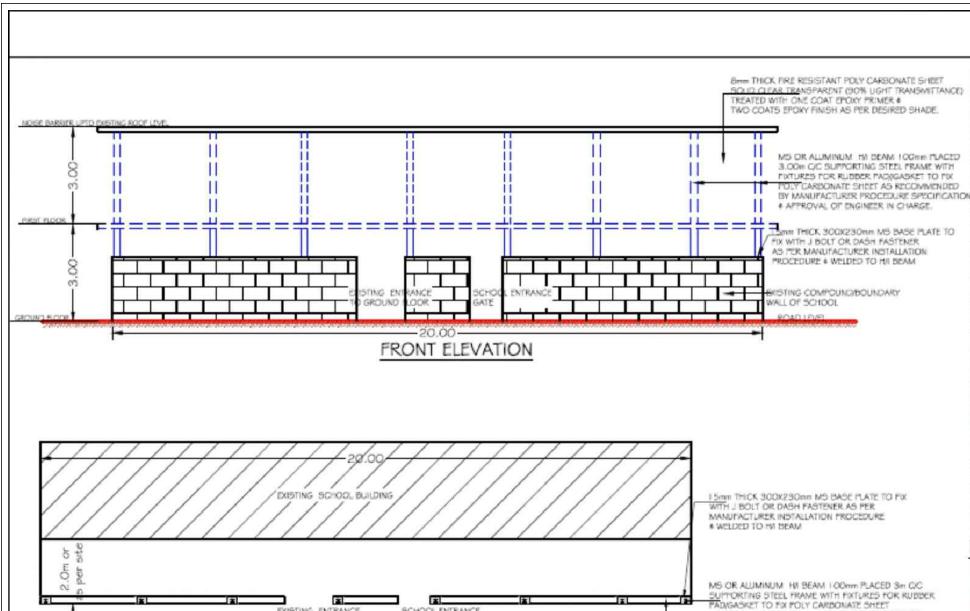

Noise barrier to be installed on the existing boundary wall of school.

TO GROUND FLOOR

PLAN

ii) All dimensions shown are to be verified at site.

NOGE BARRIER TO BE INSTALLED AT BOUNDARY WALL

- III) Noise barrier design and general arrangement to be confirmed with school authorities.
- iv) All dimensions are in metres unless otherwise specified.

FIG .:- 7-14 OISE BARRIER AT CH. 22+545 (UNITY PUBLIC SCHOOL)

SCHOOL ENTRANCI

221500

LOCATION PLAN



PRESENT SITE PHOTOGRAPH AT CH.22+545

DESIGNED

CHECKED

tems for Nosie Barrier at Ch 22+545 for Unity Public School

- about the noise barrier design, general arrangement and installation requirements and benefits of reduction in ambient noise levels for the school due to installation of noise
- 2. Consultation during ESIA with School authorities had broadly indicated no objection to installation of noise barrier in front of school, if it does not obstruct the light and at
- 3. Plan and schedule the installation of noise barrier during school holidays and/or weekends to avoid disruption to school activities and ensure utmost safety to school children. Examination days shall be strictly avoided for any construction activity near school premises
- 4. Plan and complete the installation of noise barrier in ONE -GO and in limited time frame Installation of Noise barriers in multiple schedules shall be avoided to the extent
- 5. Ensure the entire installation of noise barrier at school premises by the supplier/fabricator is well supervised and all required safety measures for school children and public and road users including plying traffic during installation
- 6. Ensure the noise barrier is adequately designed, fabricated and installed to withstand the known maximum wind speed known for the region and as per relevant as per standards
- Removal and/or clearing of unwanted debris/wate material in the premises and/or or road during installation of noise barrier and disposal of the same at an approved location
- Installation of the noise barrier shall preferably completed, prior to commencement of construction related to the road widening
- "3M" make high intensity retro reflective conspiculty tape (2" wide X 1mtr length) shall be pasted along edge of road near structure

Note: Any suggestions by the school authorities or the noise barrier design, fabrication, installation, safety aspects and aesthetics shall be duly considered with prior approval of Engineer in

SHEET 01 OF 01

NOTE: The drawing given above is indicative, contractor to submit working drawing in consultation with local authorities, CSC, HPRIDC, for taking up the work.

# CLIENT:

HIMACHAL PRADESH ROAD AND OTHER INFRASTRUCTURE DEVELOPMENT CORPORATION LIMITED. DESIGNED DRAWN CHECKED APPROVED

CONSULTANT: SATZA SATRA SERVICES AND SOLUTIONS PVT LTD. #1-8-359 to 363, 4th Floor,Centre Point Building,SP Road, Begumpe Secunderabad,Telangana – 500003, India. Tel: +91 40 2784 0040, Fax: +91 40 2784 0050, E-mail: info@satragroup.in, Web: www.satragroup.in

EXISTING COMPOUNDING

WALL OF SCHOOL

PROJECT: Himachal Pradesh State Roads Transformation Project (HPSRTP) NOT TO SCALE

AS RECOMMENDED BY MANUFACTURER PROCEDURE


SPECIFICATIONS # ATTROVAL OF ENGINEER IN CHARGE


MADHU.K CS/AH

TENDER PURPOSE ONLY TITLE: **NOISE BARRIER** AT KM 22+545 (UNITY PUBLIC SCHOOL).

DRAWING NO: HP/MAN-KAL/NB-001

ROAD NAME: Package-VI: Upgradation of Mandi - Rewalsar - Kalkhar Road in Mandi District From Km 11+000 To Km 27+854

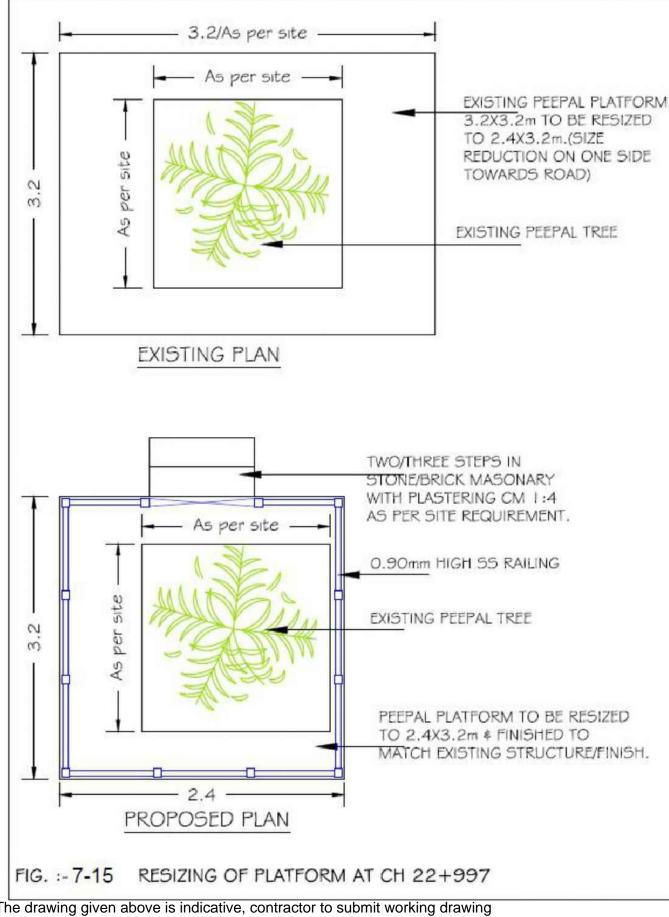

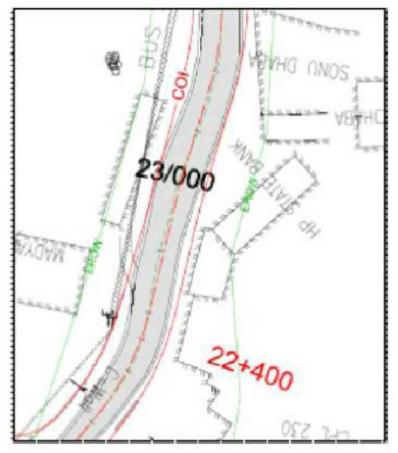

LOCATION PLAN



PRESENT SITE PHOTOGRAPH AT CH 22+997

PROJECT:

## Items for Resizing and renovation of Religious Shrine at Ch 22+997

- 1. Partly dismantle the existing platform, towards the roadside as per dimensions shown in the drawing/site requirements, to avoid impact on the shrine
- 2. Reconstruct the platform as per re-sizing requirements with match the same finish (to extent possible) to the entire masonry work and carryout minor repairs like filling up cracks and redoing broken edges and sides as required /per site condition
- 3. Providing and Fixing of SS railing all along the edge of the platform (900 mm height and 20 metre long)
- 4. Providing two coats of exterior paint/white washing to the entire religious as per site conditions/site requirements
- 5. Removal and/or clearing of unwanted debris/wate material surrounding the shrine and disposal of the same at an approved location
- 7. "3M" make high intensity retro reflective conspicuity tape (2" wide X 1mtr length) shall be pasted along edge of road near structure

Note: All resizing and renovation /conservation work at the religious shrine shall be carried out in close consultation with local community leaders/regular users of shrine. All suggestions shall be duly considered with prior approval Engineer-in-Charge.

NOTE: The drawing given above is indicative, contractor to submit working drawing in consultation with local authorities, CSC, HPRIDC, for taking up the work.

# HIMACHAL PRADESH ROAD AND OTHER INFRASTRUCTURE DEVELOPMENT CORPORATION LIMITED. DESCRIPTION DESIGNED DRAWN CHECKED APPROVED

# CONSULTANT:



SATRA SERVICES AND SOLUTIONS PVT LTD. #1-8-359 to 363, 4th Floor,Centre Point Building,SP Road, Begumpe Secunderabad,Telangana – 500003, India. Tel: +91 40 2784 0040, Fax: +91 40 2784 0050, E-mail: info@satragroup.in, Web: www.satragroup.in

# Himachal Pradesh State Roads Transforn Project (HPSRTP)

NOT TO SCALE


	DESIGNED	MADHU.K	TI
mation	DRAWN	DANIEL	DF
	CHECKED	CS/AH	RC
	APPROVED	PRADEEP KAPLA	U

#### **TENDER PURPOSE ONLY** ITLE: **RESIZING OF PLATFORM** AT KM 22+997

RAWING NO: HP/MAN-KAL/RS-001

OAD NAME : Package-VI: Jpgradation of Mandi - Rewalsar - Kalkhar Road in Mandi District From Km 11+000 To Km 27+854

SHEET 01 OF 05

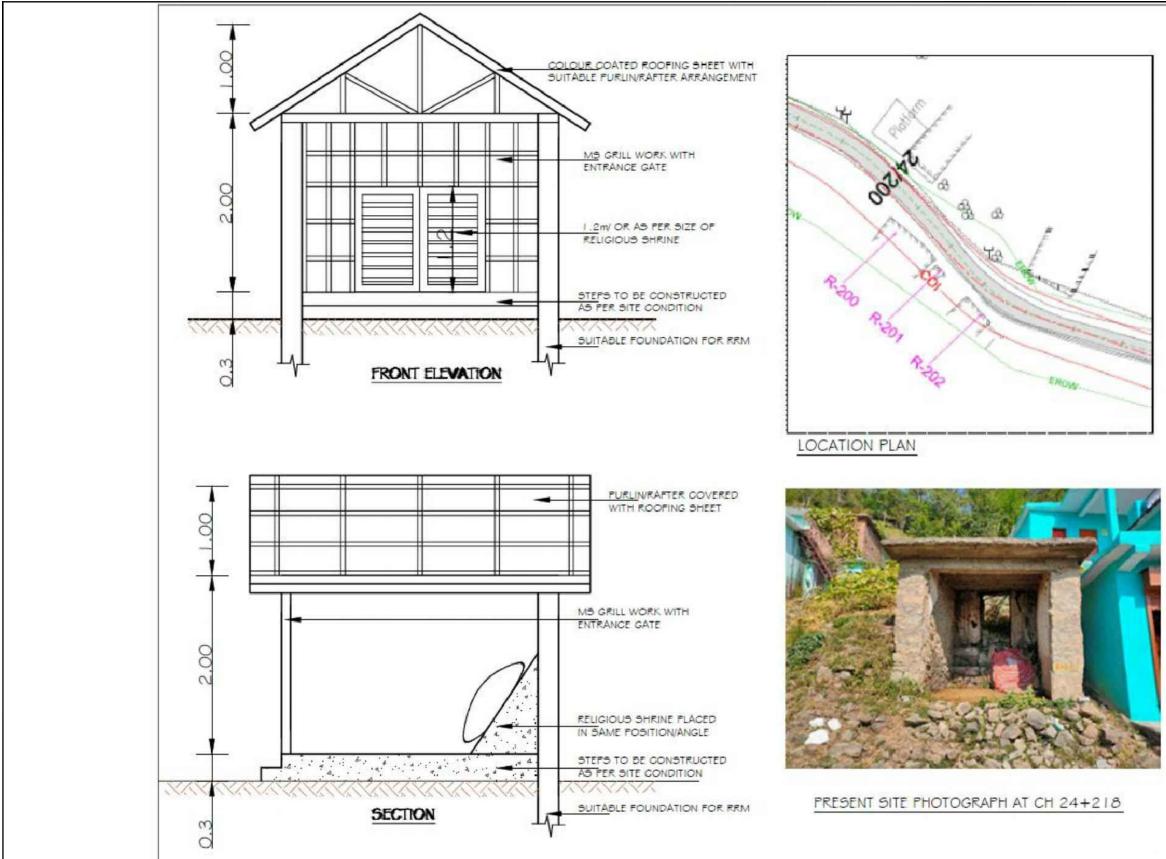

RELOCATION OF RELIGIOUS SHRINE AT CH 24+218

<u>Items for Relocation of Religious</u> Shrine at Ch 24+218

- Identify a suitable location, within the proximity of existing location of the shrine but beyond the construction disturbance zone, in consultation with the local community leaders and or regular visitors to shrine
- Clear and prepare the identified site for construction of platform as shown in the drawings/as per site requirements
- All construction work for relocation of shrine shall be undertaken as shown in drawing /site construction and as agreed upon with the local community leaders and or regular visitors to shrine
- All relocation work shall be completed prior to commencement of construction works related to road widening
- Ensure utmost care and the shrine is handled diligently and carefully, while shifting from its existing location to the new location, in cooperation and/or consultation with local community leaders and or regular visitors to shrine
- All works related to relocation of the religious shrine shall be essentially completed prior to commencement of construction related to the road widening works
- 7. Once the relocation is completed and all civil works are completed as shown in drawings/site requirements, facilitate a pooja ceremony to the satisfaction of local community/ regular visitors prior to handing over of the shrine
- "3M" make high intensity retro reflective conspicuity tape (2" wide X 1mtr length) shall be pasted along edge of road near structure


Note: All relocation work including the civil works shall be carried out in close consultation with local community leaders/regular users of shrine. All suggestions shall be duly considered with prior approval of Engineer-in-Charge.


**45** | Page

NOTE: The drawing given above is indicative, contractor to submit working drawing in consultation with local authorities, CSC, HPRIDC, for taking up the work.

FIG. :- 7-16

CLIENT:	CONSULTANT:	PROJECT:  Himachal Pradesh State Roads Transformation Project (HPSRTP)	DESIGNED		TITLE: RELOCATION OF RELIGIOUS SHRINE AT KM 24+218.	
HIMACHAL PRADESH ROAD	SATRA		DRAWN	DANIEL	DRAWING NO : HP/MAN-KAL/RS-002	
AND OTHER INFRASTRUCTURE DEVELO	PMENT SATRA SERVICES AND SOLUTIONS PVT LTD.  #1-8-359 to 363, 41 Floor, Centre Point Building, SP Road, Begumpet, Secunderabad, Telangana – 500003, India.		CHECKED	CS/AH	ROAD NAME: Package-VI:	
REV DATE DESCRIPTION DESIGNED DRAWN CHECKED APPROVED	Tel: +91 40 2784 0040, Fax: +91 40 2784 0050, E-mail: info@satragroup.in, Web: www.satragroup.in	SCALE: NOT TO SCALE	APPROVED	PRADEEP KAPLA	Upgradation of Mandi - Rewalsar - Kalkhar Road in Mandi District From Km 11+000 To Km 27+854	T 02 <b>0F</b> 05

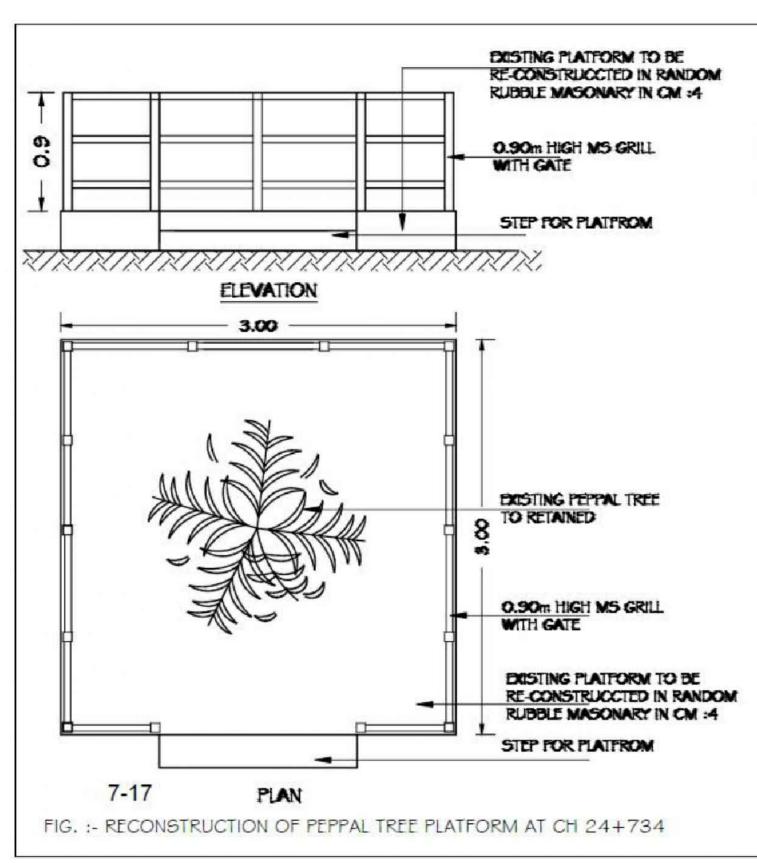

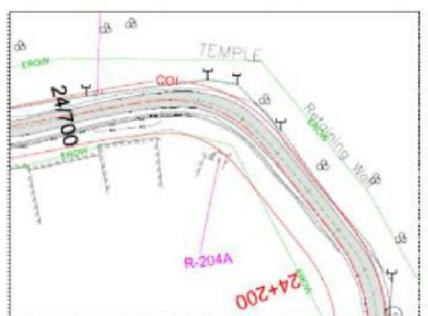

# LOCATION PLAN



PRESENT SITE PHOTOGRAPH AT CH 24+734


### Items for Renovation of Religious Shrine at Ch 24+734

- Dismantle existing masonry of the platform and scavenge/segregate the materials, which can be reused for reconstruction of masonry along with new materials as per required /shown in Drawings and site requirements
- Provide and reconstruct the platform around the peepal tree as per dimensions shown in Drawings and space availability as per site conditions
- Construct masonry steps to facilitate ease of entry and exit to the shrine, providing with SS hand railing as shown in the drawing/site requirements
- Providing cement 12 mm thick plastering in CM 1:4 to all external surfaces of the platform with a neat coat of cement finish
- Providing and Fixing of SS railing all along the edge of the platform (900 mm height and 20 metre long)
- Providing two coats of exterior paint/white washing to the entire super structure of dug well including anti corrosive painting to M S frame supporting the fly wheel as per site requirements
- Removal and/or clearing of unwanted debris/wate material surrounding the dug well and disposal of the same at an approved location
- "3M" make high intensity retro reflective conspicuity tape (2" wide X 1mtr length) shall be pasted along edge of road near structure

Note: All renovation /conservation work at the religious shrine shall be carried out in close consultation with local community leaders/regular users of shrine. All suggestions shall be duly considered with prior approval of Engineer-in-Charge.

NOTE: The drawing given above is indicative, contractor to submit working drawing in consultation with local authorities, CSC, HPRIDC, for taking up the work.

		CLIENT:	CONSULTANT:	PROJE	CT:	DESIGNED	MADHU.K	TITLE: RECONSTRUCTION OF PEPPAL TREE PLATFORM AT KM 24+734.	
	HIMACHAL PRADESH ROAD  SATÇA		SATRA	Himachal Pradesh State Roads Transformation Project (HPSRTP)		DRAWN	DANIEL	DRAWING NO : HP/MAN-KAL/RS-003	
		AND OTHER INFRASTRUCTURE DEVELOPMENT CORPORATION LIMITED.	T SATRA SERVICES AND SOLUTIONS PVT LTD. #1-8-359 to 363, 4th Floor,Centre Point Building,SP Road, Begumpet, Secunderabad,Telangana – 500003, India.		* * *	CHECKED	CS/AH	ROAD NAME : Package-VI:	
REV DAT	E DESCRIPTION DESIGNED DRAWN CHECKED /	APPROVED	Tel: +91 40 2784 0040, Fax: +91 40 2784 0050, E-mail: info@satragroup.in, Web: www.satragroup.in	SCALE:	NOT TO SCALE	APPROVED	PRADEEP KAPLA	Upgradation of Mandi - Rewalsar - Kalkhar Road in SHEET 03 OF 05 Mandi District From Km 11+000 To Km 27+854	

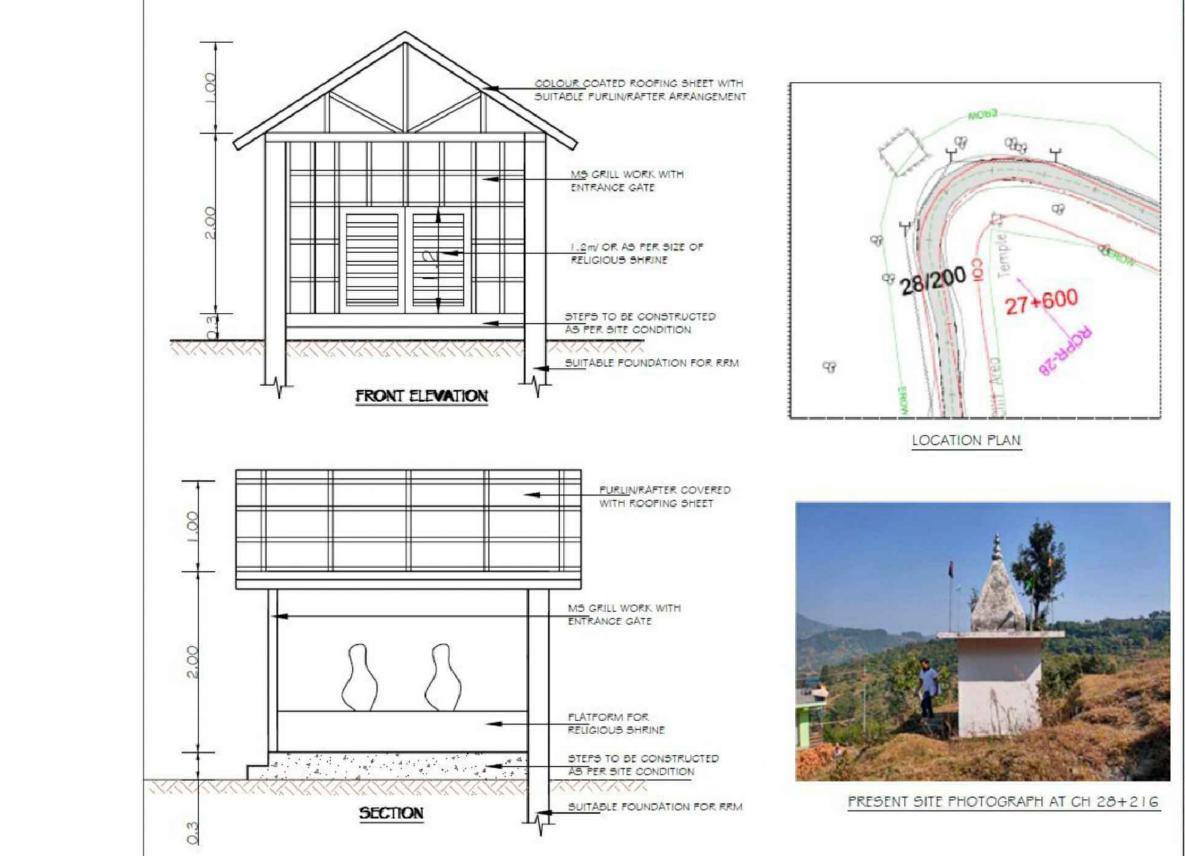

Items for Relocation of Religious Shitems for Relocation of Religious Shrine at Ch 28+216

- 1. Identify a suitable location, within the proximity of existing location of the shrine but beyond the construction disturbance zone, in consultation with the local community leaders and or regular visitors to shrine
- 2. Clear and prepare the identified site for construction of platform as shown in the drawings/as per site
- 3. All construction work for relocation of shrine shall be undertaken as shown in drawing /site construction and as agreed upon with the local community leaders and or regular visitors to shrine
- 4. All relocation work shall be completed prior to commencement of construction works related to road widening
- 5. Ensure utmost care and the shrine is handled diligently and carefully, while shifting from its existing location to the new location, in cooperation and/or consultation with local community leaders and or regular visitors to shrine
- 6. All works related to relocation of the religious shrine shall be essentially completed prior to commencement of construction related to the road widening works
- 7. Once the relocation is completed and all civil works are completed as shown in drawings/site requirements, facilitate a pooja ceremony to the satisfaction of local community/ regular visitors prior to handing over of the shrine
- 7. "3M" make high intensity retro reflective conspicuity tape (2" wide X 1mtr length) shall be pasted along edge of road near structure

Note: All relocation work including the civil works shall be carried out in close consultation with local community leaders/regular users of shrine. All suggestions shall be duly considered with prior approval of Engineer

NOTE: The drawing given above is indicative, contractor to submit working drawing in consultation with local authorities, CSC, HPRIDC, for taking up the work.

7-18

FIG. :-

CONSULTANT: HIMACHAL PRADESH ROAD AND OTHER INFRASTRUCTURE DEVELOPMENT CORPORATION LIMITED. DESCRIPTION DESIGNED DRAWN CHECKED APPROVED

SATZA

RELOCATION OF RELIGIOUS SHRINE AT CH 28+216

SATRA SERVICES AND SOLUTIONS PVT LTD. #1-8-359 to 363, 4th Floor,Centre Point Building,SP Road, Begumpet Secunderabad,Telangana – 500003, India.
Tel: +91 40 2748 4004, Fax. +91 40 2784 0050,
E-mail: info@satragroup.in, Web: www.satragroup.in Himachal Pradesh State Roads Transformation Project (HPSRTP)

NOT TO SCALE

PROJECT:

DESIGNED MADHU.K CHECKED CS/AH PRADEEP KAPLA


TENDER PURPOSE ONLY TITLE: **RELOCATION OF** RELIGIOUS SHRINE AT KM28+216.

DRAWING NO: HP/MAN-KAL/RS-004 ROAD NAME: Package-VI:

Upgradation of Mandi - Rewalsar - Kalkhar Road in SHEET 04 OF 05 Mandi District From Km 11+000 To Km 27+854



PRESENT SITE PHOTOGRAPH AT CH 28+415

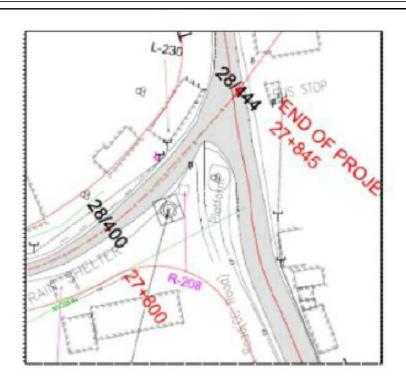

LOCATION PLAN



900mm HIGH 55 RAILING ALL AROUND PLATFORM AS PER SITE REQUIREMENT

MINOR REPAIR TO MASONARY PLATFORM \$ 12mm THICK PLASTERING IN CM 1:4

RE CONSTRUCTION OF STEPS FOR EASE OF ENTRY & EXIT OF VISITORS WITH 55 HAND RAILING AS PER SITE REQUIREMENT

PROJECT:

FIG. :- 7-19 RENOVATION OF RELIGIOUS SHRINE/PEPPAL TREE WITH PLATFORM AT CH 28+415

**TENDER PURPOSE ONLY** 

SHEET 05 OF 05

NOTE: The drawing given above is indicative, contractor to submit working drawing

in consultation with local authorities, CSC, HPRIDC, for taking up the work.

DESIGNED DRAWN CHECKED APPROVED

HIMACHAL PRADESH ROAD

AND OTHER INFRASTRUCTURE DEVELOPMENT CORPORATION LIMITED.

CONSULTANT:



SATRA SERVICES AND SOLUTIONS PVT LTD. #1-8-359 to 363, 4th Floor,Centre Point Building,SP Road, Begumpi Secunderabad,Telangana – 500003, India. Tel: +91 40 2784 0046, Fax: +91 40 2784 0050, E-mail: info@satragroup.in, Web: www.satragroup.in Himachal Pradesh State Roads Transformation Project (HPSRTP)

NOT TO SCALE

DESIGNED MADHU.K CHECKED CS/AH

TITLE: RECONSTRUCTION OF RELIGIOUS SHRINE / PEPPAL TREE WITH PLATFORM AT KM 28+415.

DRAWING NO: HP/MAN-KAL/RS-005

Items

site condition

long)

for

Religious Shrine at Ch 28+415 1. Carryout minor repairs to the entire masonry work like filling up cracks and redoing broken edges and sides as required /per

2. Providing and Fixing of SS railing all along the edge of the platform (900 mm height and 20 metre

3. Reconstruction of steps to facilitate ease of entry and exit to the shrine, providing with SS hand railing as shown in the

drawing/site requirements

4. Providing two coats of exterior

paint/white washing to the entire

religious shrine including the adjacent water tank structure for ablution purposes as per site conditions/site requirements

5. Removal and/or clearing of unwanted debris/wate material surrounding the shrine and disposal of the same at an

7. "3M" make high intensity retro reflective conspicuity tape (2" wide X 1mtr length) shall be pasted along edge of road near

Note: All renovation /conservation work at the religious shrine shall be

carried out in close consultation with

local community leaders/regular users

of shrine. All suggestions shall be duly considered with prior approval of

approved location


structure


Engineer-in-Charge.

Renovation


of


ROAD NAME: Package-VI: Upgradation of Mandi - Rewalsar - Kalkhar Road in Mandi District From Km 11+000 To Km 27+854

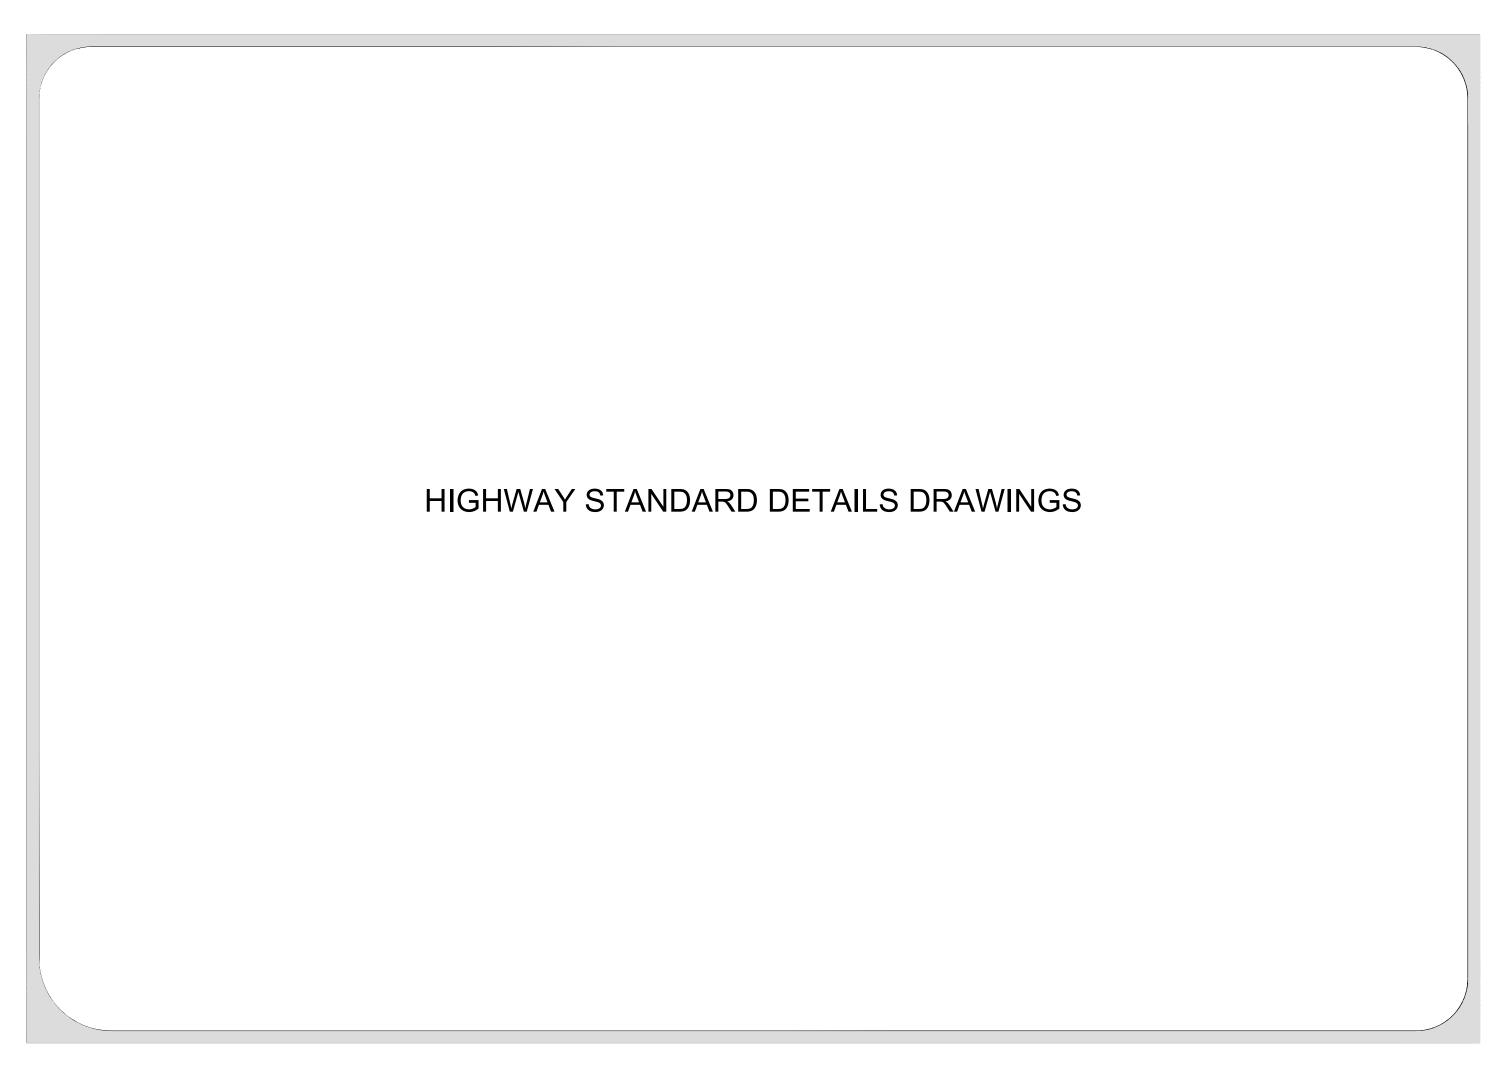

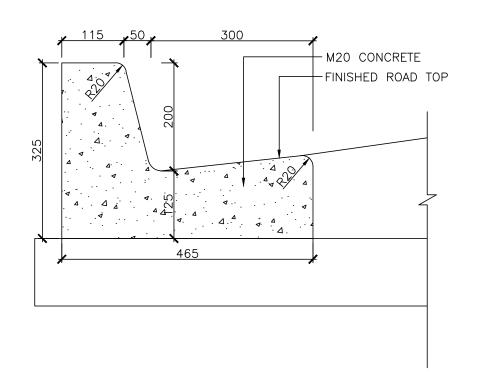

DETAILS OF KERB WITH CHANNEL

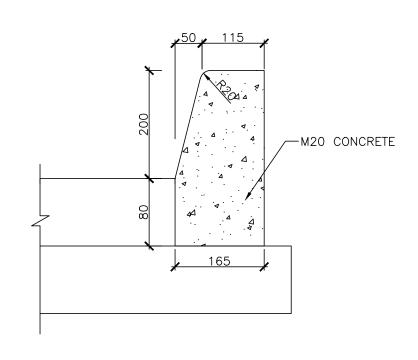

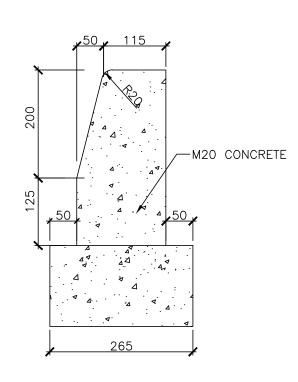

DETAILS OF KERB

**DETAILS OF KERB** 

### NOTES:

1. GRADE OF CONCRETE IS M20.

CLIENT: HIMACHAL PRADESH ROAD AND OTHER INFRASTRUCTURE DEVELOPMENT SATRA SERVICES AND SOLUTIONS PVT LTD. CORPORATION LIMITED. REV DATE DESCRIPTION DESIGNED DRAWN CHECKED APPROVED

CONSULTANT:



#1-8-359 to 363, 4th Floor,Centre Point Building,SP Road, Begumpet, Secunderabad,Telangana – 500003, India.
Tel: +91 40 2784 0040, Fax: +91 40 2784 0050,
E-mail: info@satragroup.in, Web: www.satragroup.in


PROJECT:
Himachal Pradesh State Roads Transformation
Project (HPSRTP)


NOT TO SCALE


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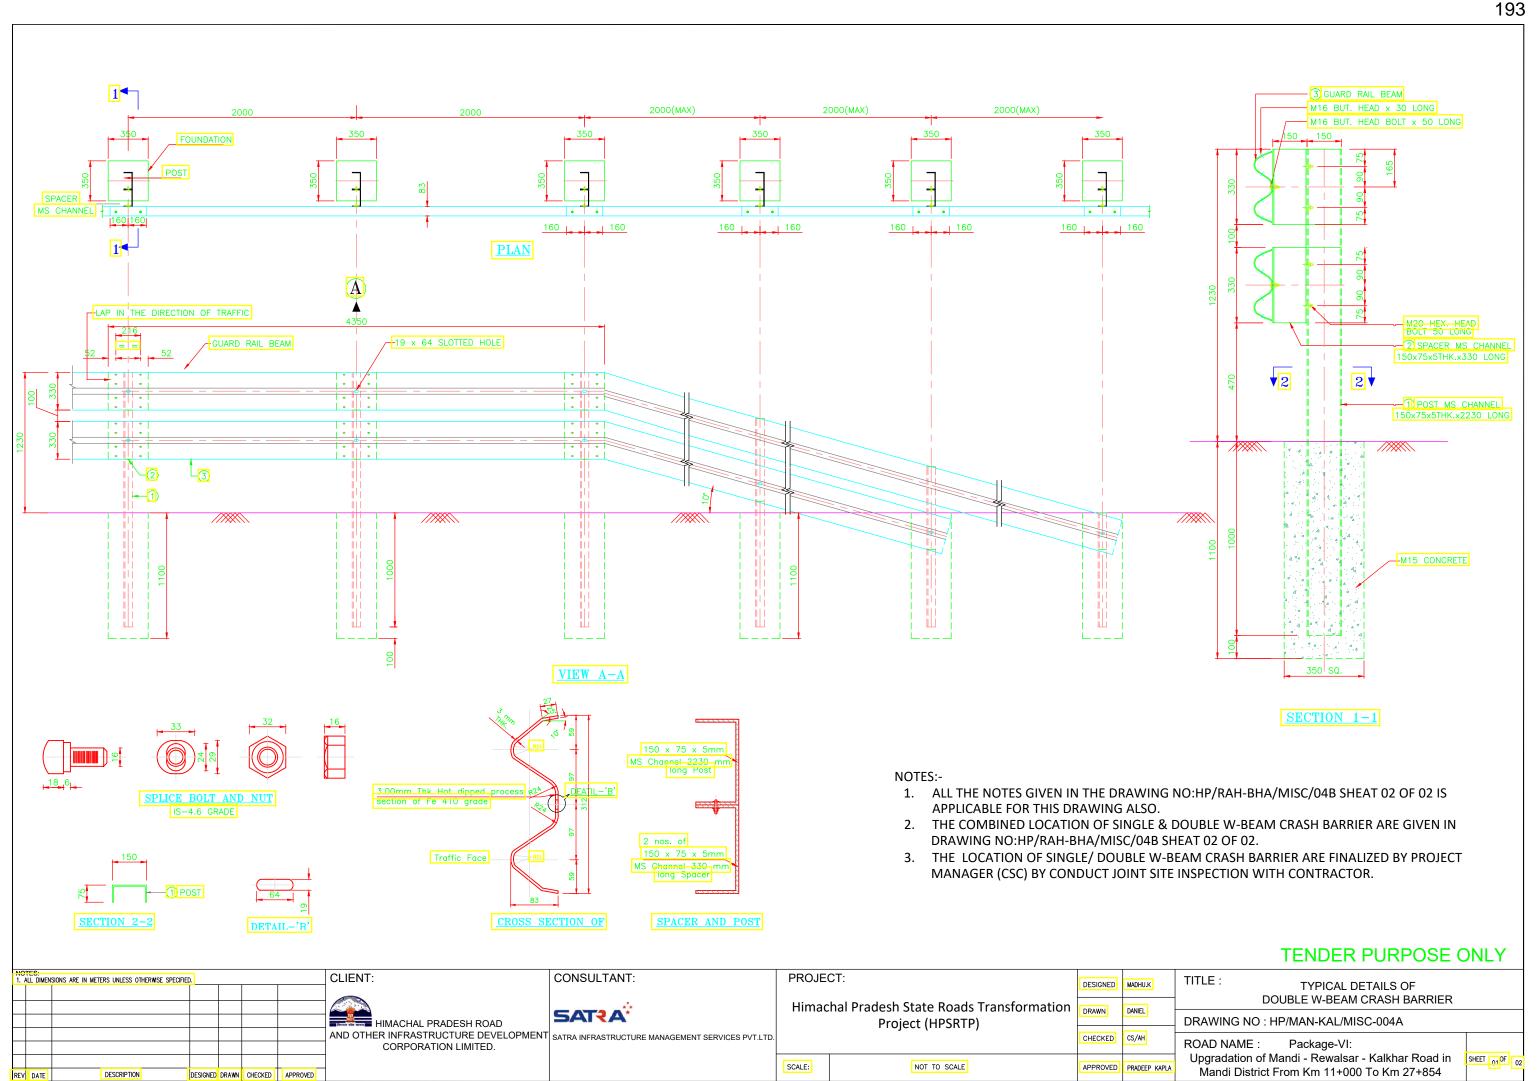
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DDAWAL	DANIEL	
DRAWN		DRAWING NO : HP/MAN-KAL/MISC
CHECKED	CHANDRA/ASHIK	ROAD NAME : Package-VI:
APPROVED	PRADEEP KAPLA	Upgradation of Mandi - Rewalsar - K

OF KERB C-001 Kalkhar Road SHEET 01 OF 01 in Mandi District From Km 11+000 To Km 27+854



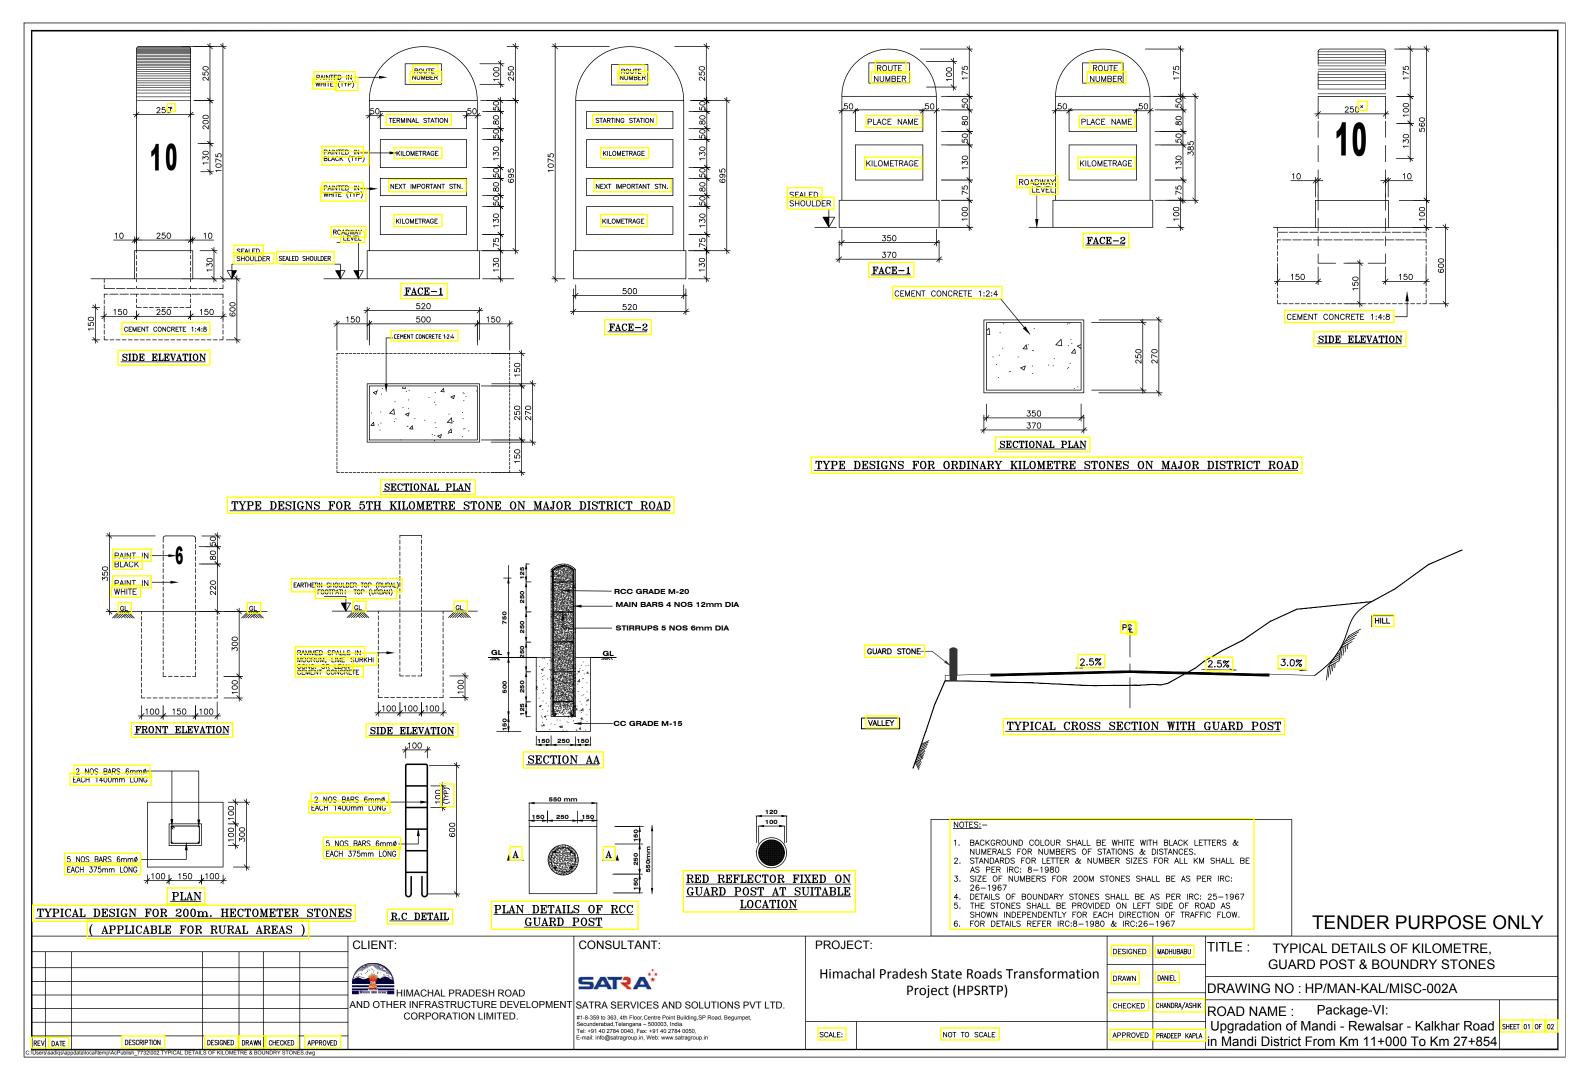

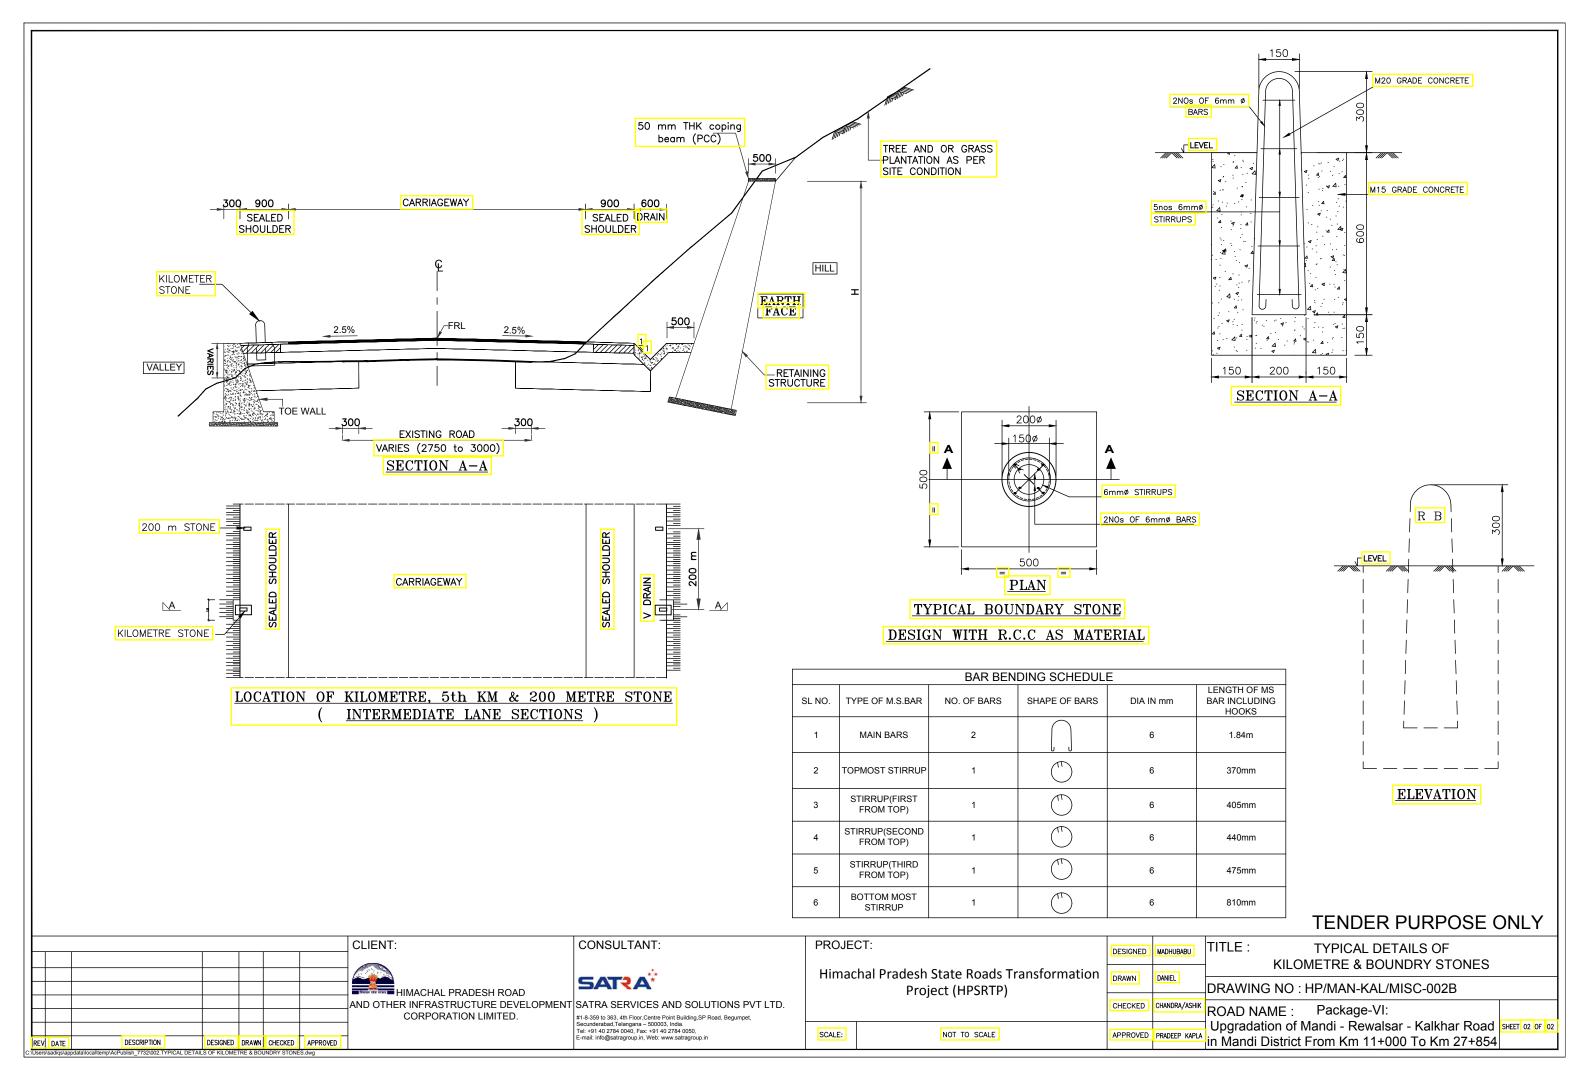

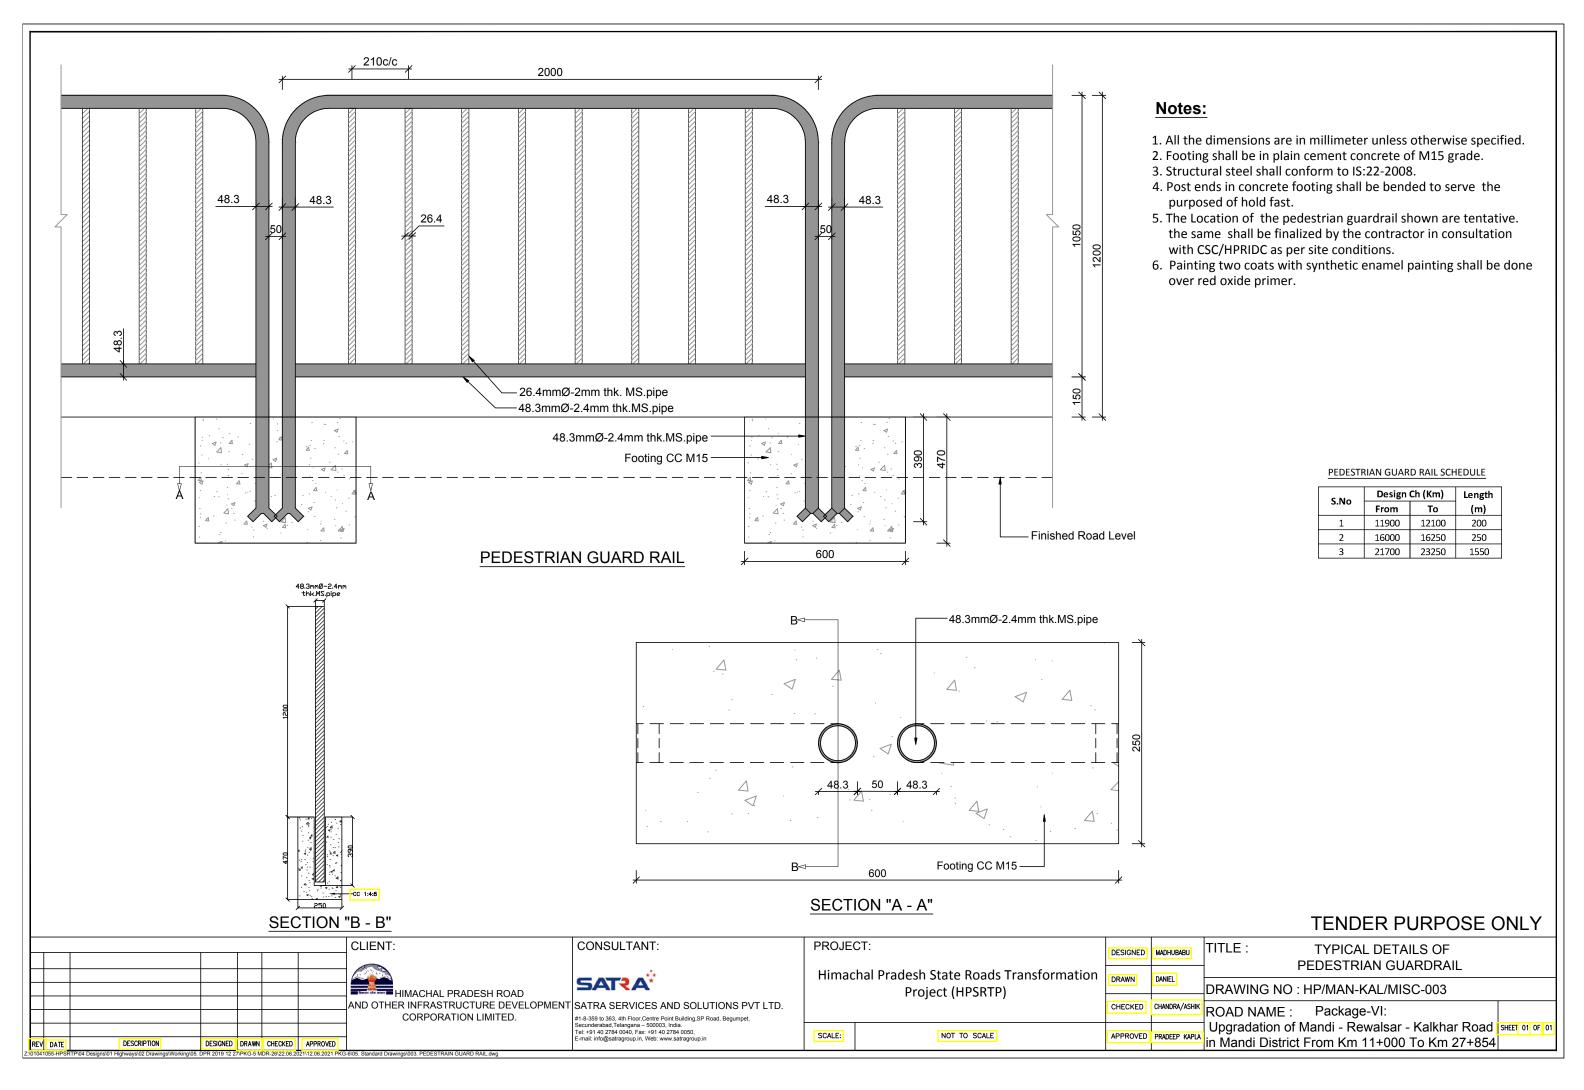

Side

LHS

THS

LHS

CRASH BARRIER SCHEDULE

Length

(m)

above

OGL(m)

Design Ch (Km)

From

110 27670


111 27710

113 27810

102 27170

94 26300

78 24610

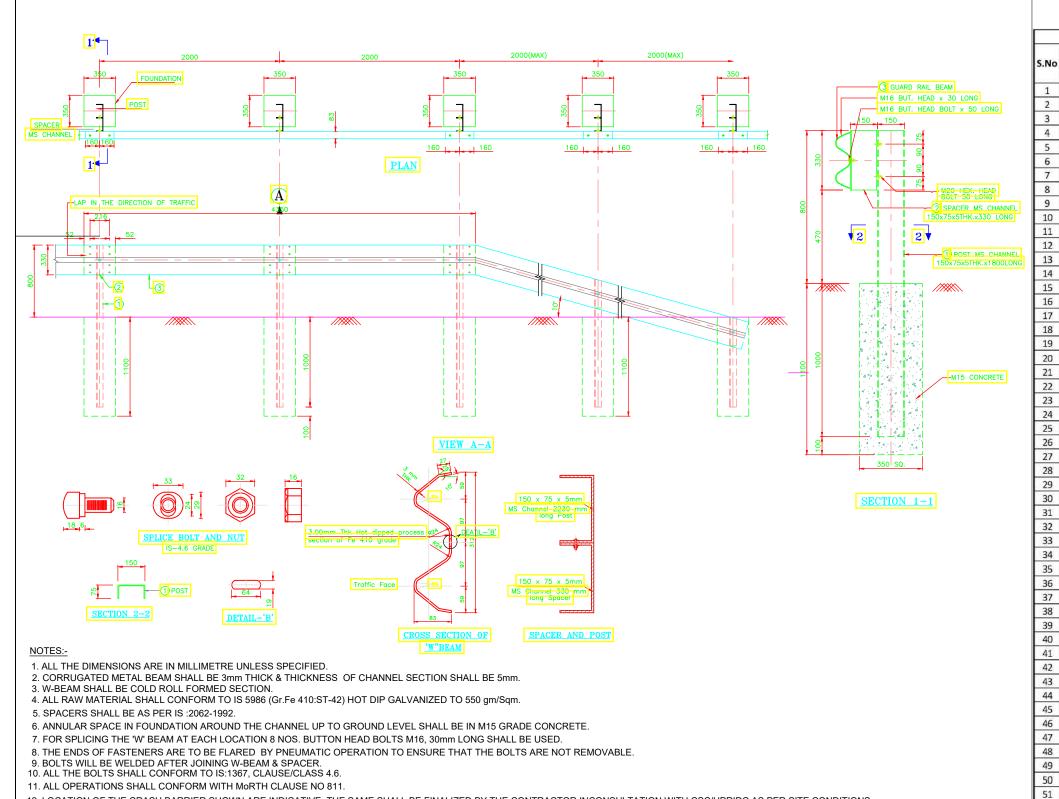

11. ALL OPERATIONS SHALL CONFORM WITH MORTH CLAUSE NO 811.

. ALL DIMENSIONS ARE IN METERS UNLESS OTHERWISE SPECIFIED.

DESCRIPTION

REV DATE

- 12. LOCATION OF THE CRASH BARRIER SHOWN ARE INDICATIVE. THE SAME SHALL BE FINALIZED BY THE CONTRACTOR INCONSULTATION WITH CSC/HPRIDC AS PER SITE CONDITIONS.
- 13. RETRO REFLECTIVE STRICKERS OF 30CM WIDE (20r3 COLOUR) SHALL BE PROVIDED ON TOP W BEAM AT ALTERNATIVE POST LOCATION.

CLIENT:

DESIGNED DRAWN CHECKED APPROVED

- 14. THE METAL SAFETY BARRIER SHALL BE COMPLIANT WITH TEST ACCEPTANCE CRITERIA OF EUROPEAN EN1317-2 STANDARD (OR) NCHRP 350 FOR CONTAINMENT LEVELS OF N2,H1 (OR) NCHRP 350 FOR CONTAINMENT LEVELS TL-3 & TL-4.
- 15. THE CONTVACTOR SHALL PROVIDE ALL APPLICABLE CRASH TEST REPORTS THAT CONFORM THE BARRIER TO HAVE PASSED THE CRASH TESTS CONDUCTED BY AN INTERNATIONAL ACCREDITED CRASH TESTING LABORATORY HAVING ALL THE TESTING FACILITIES.

CONSULTANT:

16. THE DISTANCE BETWEEN THE BARRIER AND THE STAND OF THE EMBANKMENT/HAZARD TO PROVIDE ADEQUATE SUPPORT FOR THE PROPER OPERATION. WHERE SPACE IS CONSTRAINED AND LESSER SPACE IS AVAILABLE FOR DEFLECTION AND IS RECOMMENDED 1.5m SPACING IN BETWEEN POSTS.

#### THE LOCATION OF SINGLE/ DOUBLE W-BEAM CRASH BARRIER ARE FINALIZED BY PROJECT MANAGER (CSC) BY CONDUCT JOINT SITE INSPECTION WITH CONTRACTOR.

				ı
				, 1
			HIMACHAL PRADESH ROAD	ı
			AND OTHER INFRASTRUCTURE DEVELOPMENT SATRA INFRASTRUCTURE MANAGEMENT SERVICES PVT.LTD.	ı
			CORPORATION LIMITED.	L
				_

LCHON	WITH CONTRACTOR.				
PROJE	CT:	DESIGNED	MADHU.K		
Himac	hal Pradesh State Roads Transfor Project (HPSRTP)	DRAWN	DANIEL		
			CHECKED	CS/AH	
SCALE:	NOT TO SCALE		APPROVED	PRADEEP KAPLA	

	TENDER PURPOSE (	ONLY
TITLE :	TYPICAL DETAILS OF SINGLE W-BEAM CRASH BARRIER	

DRAWING NO: HP/MAN-KAL/MISC-004B

ROAD NAME: Package-VI: Upgradation of Mandi - Rewalsar - Kalkhar Road in

CRASH BARRIER SCHEDULE

Length

(m)

Side

LHS

THS

LHS

LHS

LHS

LHS

THS

LHS

LHS

LHS

THS

LHS

LHS

THS

LHS

THS

LHS

LHS

LHS

LHS

LHS

LHS

LHS

LHS

above


OGL(m

S.No


Design Ch (Km)

From

SHEET 02 DF 02 Mandi District From Km 11+000 To Km 27+854

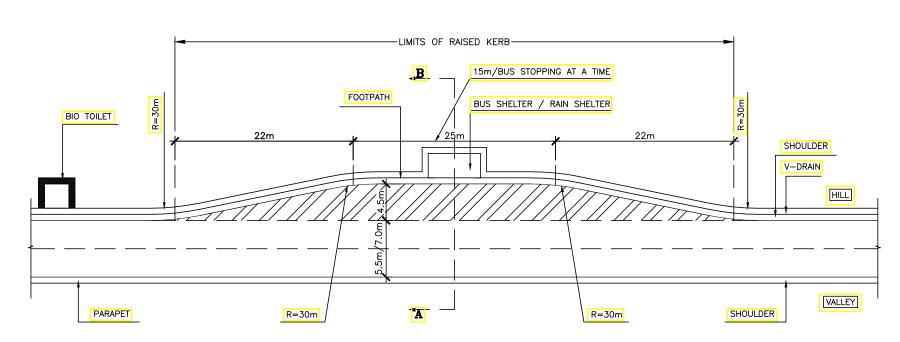

#### TYPICAL PLAN OF BUS BAY

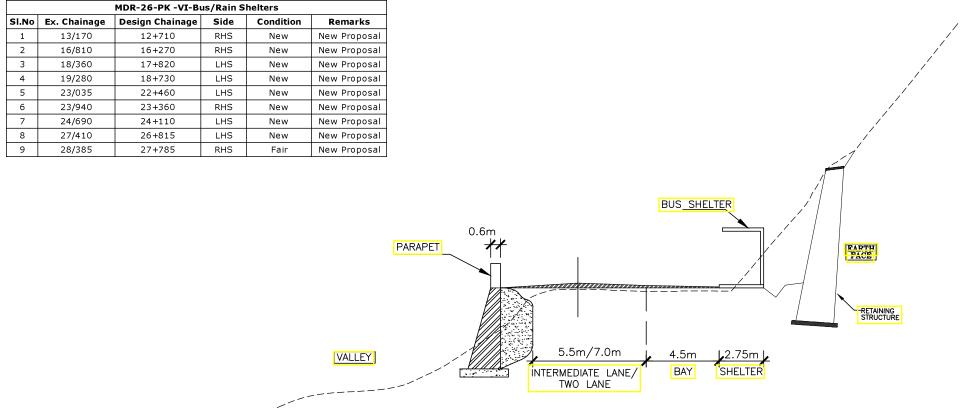


### SECTION THROUGH ROAD AT AB

#### NOTES:


- 1. ALL DIMENSIONS ARE IN METRES UNLESS OTHERWISE SPECIFIED.
  2. FOR OTHER DETAILS PLEASE REFER IRC -SP-48 1998
- 3. ADEQUATE FACILITIES FOR EFFICIENT DRAINAGE OF THE BUS
- ADEQUATE FACILITIES FOR EFFICIENT DRAINAGE OF THE E STOP AREA INCLUDING LAY—BYES SHOULD BE ENSURED.
- PAVEMENT MARKINGS SHOULD BE PROVIDED AS INDICATED ON THE DRAWING. THE WORD BUS SHOULD BE WRITTEN ON THE PAVEMENT AT THE ENTRY TO THE BUS WAY FOR DETAILED GUIDANCE SEE IRC: 35.
- GUIDANCE SEE IRC:35.


  5. IN THE BUS STOP AREA THE SHOULDER ON BUS STOP SIDE SHOULD BE RAISED TO FROM FOOTPATHS AS MARKED ON THE DRAWING.THE JUNCTION BETWEEN SHOULDER AND
- FOOTPATH SHOULD BE SUITABLY TRANSITIONED BY A RAMP.

  6. AREA FOR BUS SHELTER = 347.50 SQM.
- BUS BAY LOCATIONS SHOWN ARE INDICATIVE, ACTUAL LOCATION SHALL BE FINALIZED BY THE CONTRACTOR IN CONSULTATION WITH CSC/HPRIDC AS PER SITE CONDITION.
- 8. PROTECTION WORKS (BREAST WALL/RETAINING WALL/TOE WALL) TO THE BUS SHELTER SHALL BE FINALIZE CONSULTATION WITH CSC/HPRIDC DURING CONSTRUCTION.
- FOR THE DETAILS OF BREAST WALL REFER THE DRAWING NO:HP/MAN-KAL/MISC-017.
- 10. FOR THE DETAILS OF RETAINING WALL REFER THE DRAWING NO:HP/MAN-KAL/MISC-023.

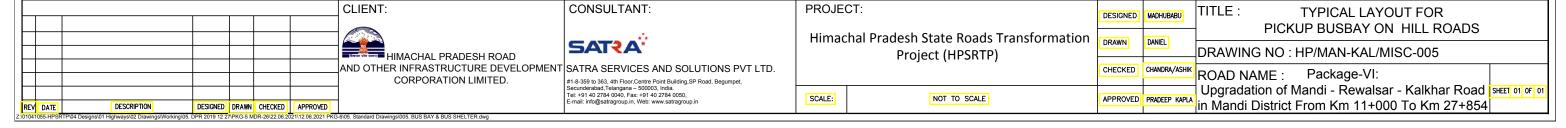

### DETAILS OF SUPERELEVATION DETAILS OF VERTICAL CURVE DETAILS OF HORIZONTAL CURVE RUNOFF LENGTH FULLY SUPERELEVATED CIRCULAR CURVE, RUNOFF LENGTH (TRANSITION) (TRANSITION) PT LC FOR VALLEY CURVE $\triangle$ FOR CIRCULAR CURVE FOR CIRCULAR CURVE IN TRANSITION AS REVOLVING AXIS EDGE OF CARRIAGE WAY WHEN THE BOTH LEFT AND RIGHT CARRIAGEWAY IS ROTATED ABOUT THE ROAD CENTRELINE LEGEND: FOR CURVILINEAR SECTION WITH TRANSITION CURVE TANGENT TO SPIRAL LENGTH OF TRANSITION (HIP) HORIZONTAL INTERSECTION POINT FOR SUMMIT CURVE SPIRAL TO CURVE TANGENT DISTANCE RUNOFF LENGTH (cs) CURVE TO SPIRAL DEVIATION ANGLE OF TRANSITION (A) TOTAL DEVIATION ANGLE DEVIATION ANGLE OF CIRCULAR CURVE LENGTH OF HORIZONTAL CURVE SPIRAL TO TANGENT (PC) POINT OF CURVATURE (LV) LENGTH OF VERTICAL CURVE (Es) APEX DISTANCE POINT OF TANGENT (g1) VERTICAL GRADIENT 2100 <u>150</u> <u>150</u> ALL DIMENSIONS ARE IN MILLIMETRES UNLESS OTHERWISE INDICATED. LANE MARKINGS & OBJECT MARKINGS HAS BEEN DONE WITH HOT THERMOPLASTIC PAINT AND IT IS IN ACCORDANCE WITH CLAUSE-803 OF "MORT&H" SPECIFICATION, REVISION III 1995. STOP LINES GIVEWAY LINES ALL MARKINGS ARE IN ACCORDANCE WITH IRC:35-2015(FIRST REVISION). **TENDER PURPOSE ONLY** CLIENT: CONSULTANT: PROJECT: TITLE: TYPICAL DETAILS OF HORIZONTAL, DESIGNED MADHUBABU **VERTICAL CURVE & SUPER ELEVATION** Himachal Pradesh State Roads Transformation HIMACHAL PRADESH ROAD DRAWN SAT?A\* DRAWING NO : HP/MAN-KAL/MISC-006 Project (HPSRTP) AND OTHER INFRASTRUCTURE DEVELOPMENT SATRA SERVICES AND SOLUTIONS PVT LTD. CHECKED CHANDRA/ASHIK ROAD NAME : Package-VI: CORPORATION LIMITED. #1-8-359 to 363, 4th Floor, Centre Point Building, SP Road, Begumpet, Secunderabad, Telangana – 500003, india. Tel: +91 40 2784 0040, Fax. +91 40 2784 0050, E-mail: info@satragroup.in, Web: www.satragroup.in Upgradation of Mandi - Rewalsar - Kalkhar Road SHEET 01 OF 01 SCALE: NOT TO SCALE APPROVED PRADEEP KAPLA in Mandi District From Km 11+000 To Km 27+854 DESIGNED DRAWN CHECKED APPROVED

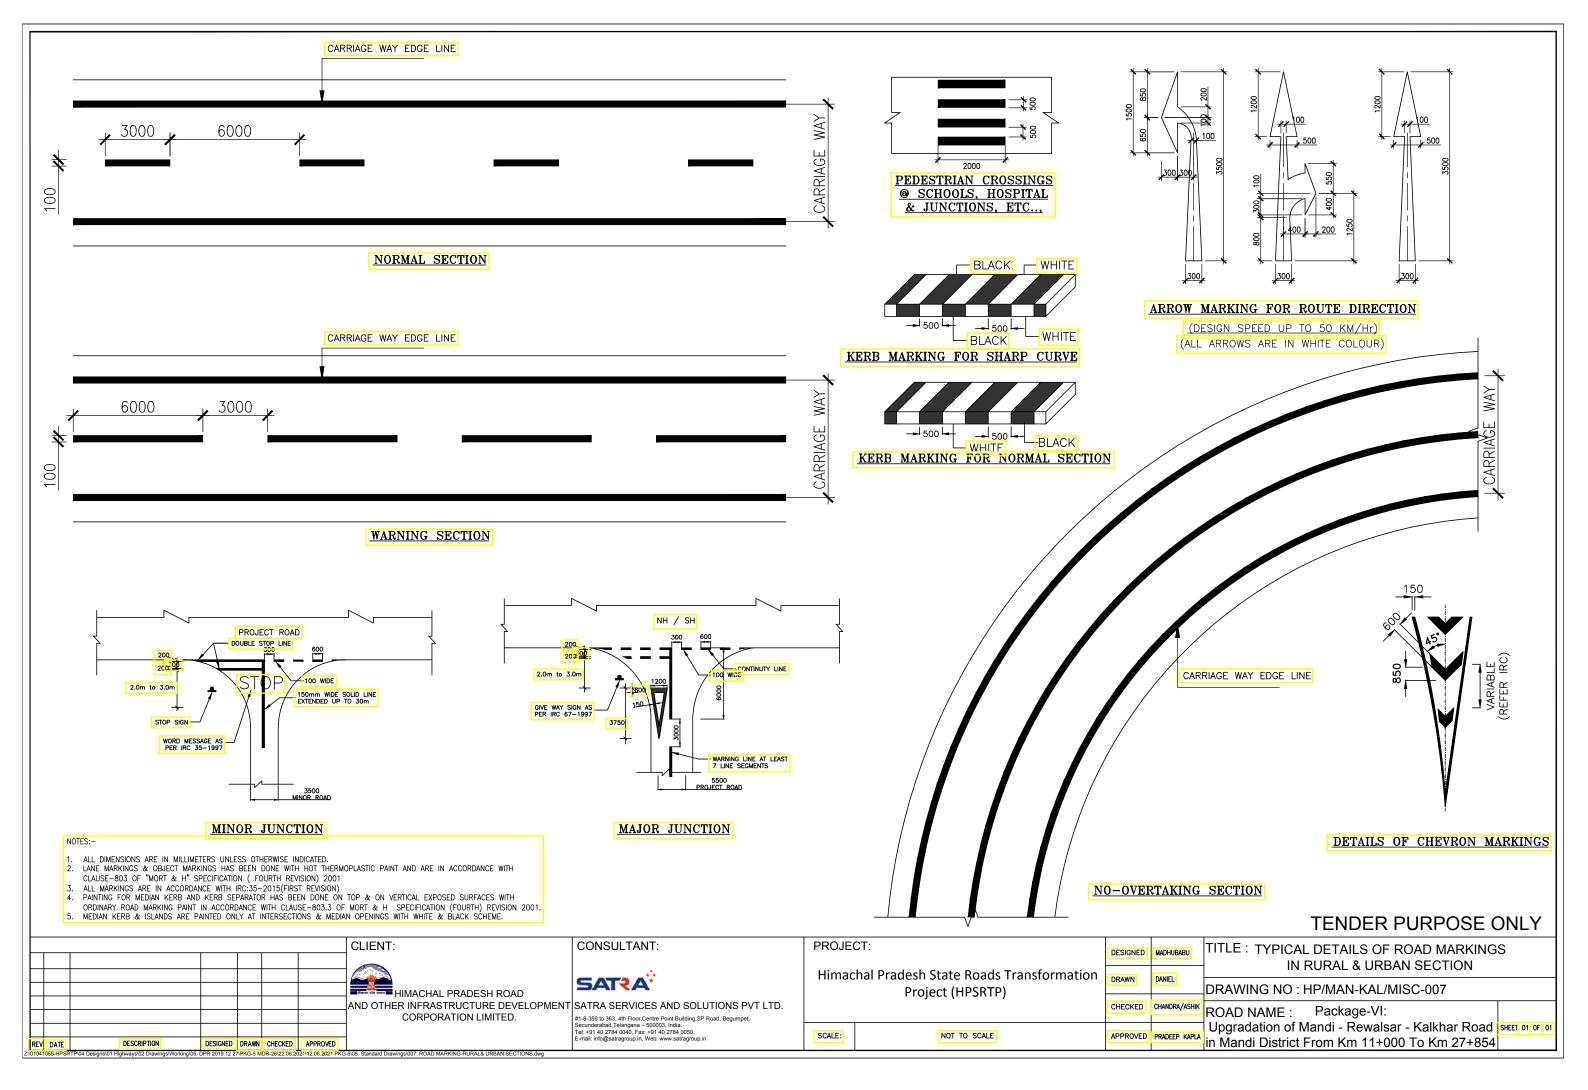


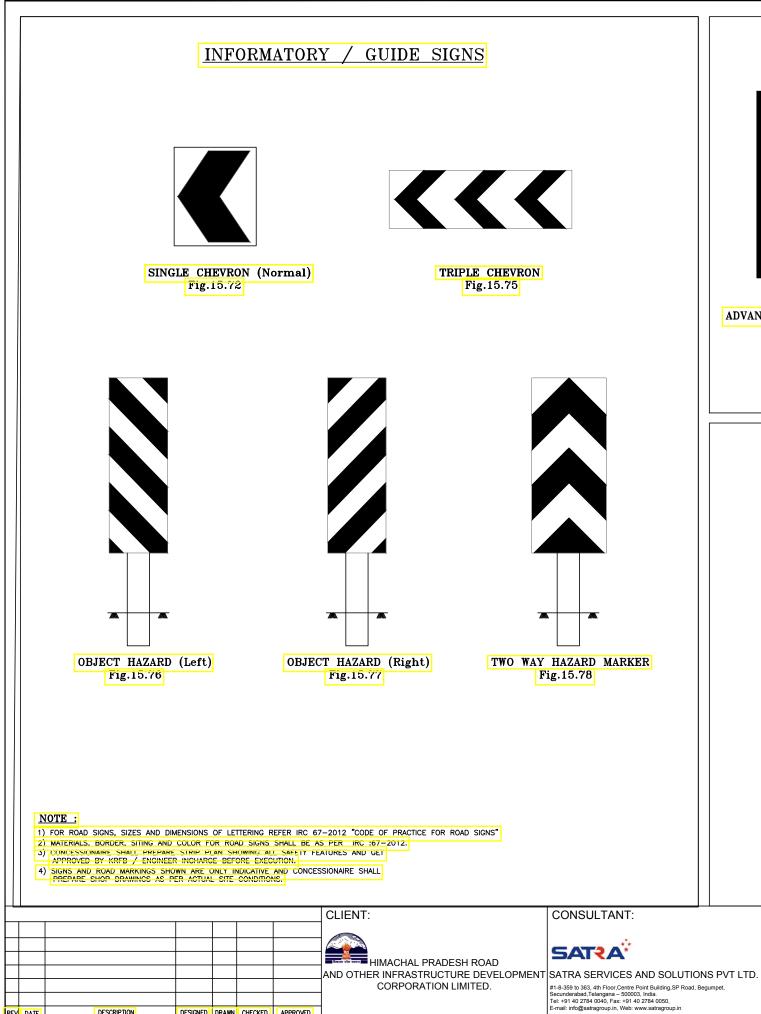

DESCRIPTION

DESIGNED DRAWN CHECKED APPROVED

REV DATE

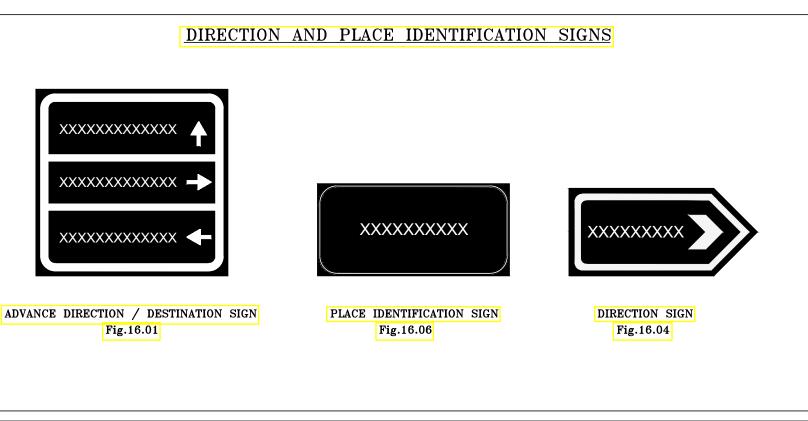












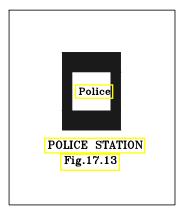


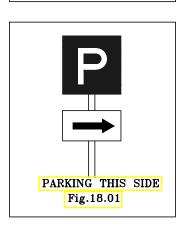

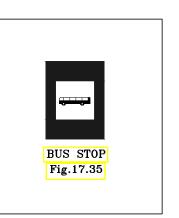



PROJEC	CT:	DESIGNED	MADHUBABU	TITLE: ROAD SIGNS (INFORMATORY SIGNS)
Himac	hal Pradesh State Roads Transformation Project (HPSRTP)	DRAWN	DANIEL	DRAWING NO : HP/MAN-KAL/MISC-008
	rroject (ili Sitti j	CHECKED		ROAD NAME : Package-VI:
SCALE:	NOT TO SCALE	APPROVED	PRADEEP KAPLA	Upgradation of Mandi - Rewalsar - Kalkhar Road आद्या ा ा । in Mandi District From Km 11+000 To Km 27+854

# MANDATORY / REGULATORY SIGNS

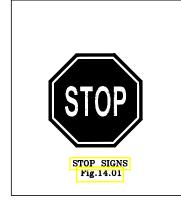




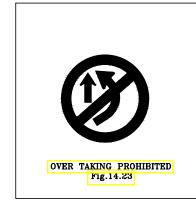

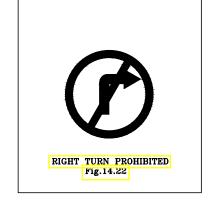



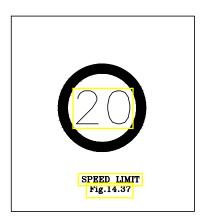


















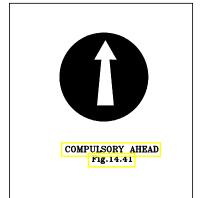

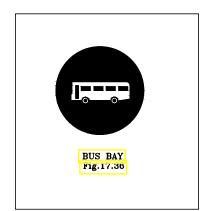

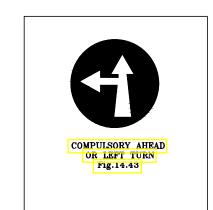

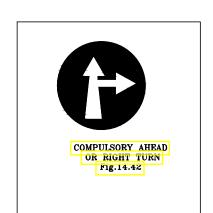

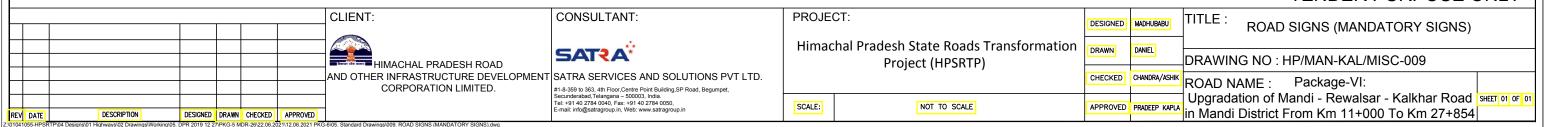

## CAUTIONARY / WARNING SIGNS
































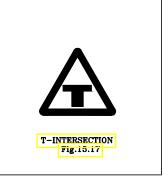













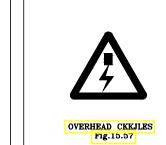

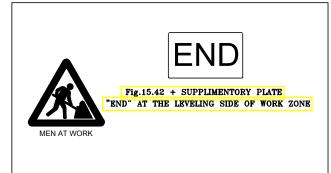




SCALE:

### NOTE: 1) FOR ROAD SIGNS, SIZES AND DIMENSIONS OF LETTERING REFER IRC 67-2012 "CODE OF PRACTICE FOR ROAD SIGNS" 2) MATERIALS, BORDER, SITING AND COLOR FOR ROAD SIGNS SHALL BE AS PER IRC :67-2012.

- CONCESSIONAIRE SHALL PREPARE STRIP PLAN SHOWING ALL SAFETY FEATURES AND GET APPROVED BY KRFB / ENGINEER INCHARGE BEFORE EXECUTION.

DESCRIPTION

REV DATE

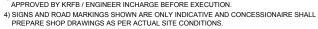


# CLIENT: HIMACHAL PRADESH ROAD CORPORATION LIMITED.

DESIGNED DRAWN CHECKED APPROVED





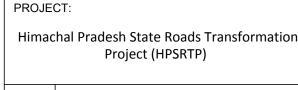

			TENDER PURPOSE ONLY
	DESIGNED	MADHUBABU	TITLE: ROAD SIGNS (WARNING SIGNS)
State Roads Transformation ect (HPSRTP)	DRAWN	DANIEL	DRAWING NO : HP/MAN-KAL/MISC-010
,	CHECKED	CHANDRA/ASHIK	ROAD NAME : Package-VI:
NOT TO SCALE	APPROVED	PRADEEP KAPLA	Upgradation of Mandi - Rewalsar - Kalkhar Road ster of or